

# Ministry of Public Works Department of Works and Engineering

**Request for Proposals** 

For

**Asphalt Plant Site Works** 

**ADDENDUM 2** 

Request for Proposals No.: PN/2024-002-Q-AP

Issued: Tuesday August 20, 2024

Submission Deadline: Friday September 6, 2024 03:00:00 PM Bermuda Local Time

#### **ADDENDUM 2**

- 1. The RFP Timetable has **not** been changed from Addenda #1.
- 2. Please refer to the attached 16 drawings that will replace previous drawings and provide extra details of the Works.
- 3. Please note that the design continues to be defined and another addenda should be expected including a bill of materials for the anchor bolts.
- 4. Please note that the site grading design may not be completed in time for the tender closing time. If this occurs the Pricing Form will be revised and re-issued to include a fixed allowance, set by the Owner, for the work and it will be re-measured as the Work progresses.


#### Questions Received to August 19, 2024

- Q1 Drawing A1.0 indicates 4 blue clouded areas defined as "Work Areas for this Tender", yet the Scope document indicates that there is site grading and filling to do. Please confirm that the full extent of this filling and grading is only within the blue clouded areas or otherwise define the entire area where other filling and grading is required.
- A1 We are working on completing the design for site grading.
- Q2 The new Access Road passes through the clouded Work Area in several locations. Is the Contractor expected to carry any costs in this respect?
- A2 No
- Q3 Drawing C1.6 indicates "For Information Only" please confirm that there are no demolition of existing Retaining Walls and Buildings and the like, or grading/filling to this area.
- A3 Correct.
- Q4 There are Boreholes indicated within the clouded Work Areas, please confirm that these are soil test boreholes or otherwise provide details for borehole construction.
- A4 No borehole work is needed, these are proposed geotechnical borehole locations, by others.
- Q5 Drawing F24-090-01 refers to Details "4" and "5". Could you please clarify which drawing these details are on or other provide these details.
- A5 Additional details are provided in this Addenda.
- Q6 On drawing F24-090-04, please confirm the height of the Wing Retaining Walls.
- A6 Drawings revised, please see drawing F24-090-10.

- Q7 Drawing A1.0 indicates 4 blue clouded areas defined as "Work Areas for this Tender", please indicate the significance of the "Dump truck with release agent sprayer" being clouded. This is also clouded on drawing C1.2. Is there some kind of foundation here? If so please provide structural details and top of concrete elevation for this foundation.
- A7 This will be a slab on grade with a wall to support the controls and a containment area for the agent, details are not available at this time. We expect the details to be ready well before the tender closes.
- Q8 Drawing A1.0 indicates 4 blue clouded areas defined as "Work Areas for this Tender". There do not appear to be any structural details for the "Plant fuel and bitumen tank" concrete bund slab or bund walls. Please provide structural details and top of concrete/bund wall elevations.
- A8 Details are included in this Addenda.
- Q9 Drawing A1.0 indicates 4 blue clouded areas defined as "Work Areas for this Tender". There do not appear to be any structural details for the "New Pay Loader Ramp for Screening Plant". Please provide structural details
- A9 Details are provided in Addenda 1.
- Q10 Astec drawing F24-090-08 (Page 26 of 35) indicates a foundation for "Reclaimed Filler Silo", but the location of this equipment is not shown on the A1.0 Site Plan/Location Plan nor is the foundation related to the WP2 setting out point. Please indicate where this equipment is to be situated.
- A10 Details are included in this Addenda.
- Astec drawings F24-090-01 to F24-090-09 (pages 19 to 27) typically indicate a top of foundation level of 100.00 which is obviously not related to the site plan levels. Please confirm that the level of the top of these foundations = 10.00. i.e. 100.00 is 10.00 and all other levels are relative.
- A11 Top of Concrete will be elev 10'-0" and a benchmark will be provided. Please delete 90ft
- Q12 Astec drawings F24-090-08 and F24-090-09 (pages 26 and 27) note that foundations are to have 12" of granular fill below them, however, the scope document seems to indicate founding on bare rock. Please clarify requirements.
- A12 The area under the footings need to be scrapped to reach bare rock under the existing asphalt, then backfilled to a level where the top of concrete sits at elev 10'-0" +/- as required
- Q13 Astec drawing 61102255 (page 17) appears to show some type of foundation for the screening plant (for arc wheel and support feet). If these are foundations, please provide structural details, dimensions and top of concrete elevations for these.
- A13 Details are included in this Addenda 1.

- Q14 Astec drawing 61102255 (page 17) showing the layout of the screening plant does not indicate any levels. Please provide elevations in this area.
- A14 Details are included in this Addenda 1.
- Assuming that all WP 2 points for the asphalt plant represent the same point, then the 5'-6" x 5'-6" foundation shown on Astec drawing F24-090-01 clashes with the large dryer tower foundation shown on Astec drawing F24-090-06. Please clarify.
- A15 Details are included in this Addenda.
- Q16 Please advise whether there is any duty relief on imported materials for this project.
- A16 100% duty free
- Q17 Will site Water and Electricity be provided by the Employer to the Contractor free of charge?
- A17 Yes, we will indicate locations during the site visit
- Q18 Will washroom facilities be made available by the Employer? If so, is there any requirement for the Contractor to maintain and clean the washrooms?
- Yes, the facilities will be made available and they must be kept clean, serviced and supplied with paper, soap, etc during the duration of the Wprks.
- Q19 Please confirm the gauge, and finish to the Chain Link and the framing etc.. e.g. galvanized, plastic coated, painted etc.
- A19 Heavy gauge galvanized.
- Q20 Is there a Door & Window Schedule available for this Project, and/or specification for hopper windows, other window, doors and roller shutter.
- A20 Details are included in this Addenda 1.
- Q21 Drawing A2.1 indicates Solar Panels to the roof of the existing BELCO Vault within the blue border. Are the supply and installation of these to be included within our Scope? If so please provide specifications and mounting details.
- A21 Not in your scope.
- Q22 With regard to drawing MEP 1.1. Please provide specifications for the mechanical scope, electrical scope, plumbing scope, lighting and fire detection.
- A22 Details are included in this Addenda 1.
- Q23 With regard to drawing MEP 1.1. Is there an electrical panel in this building? Otherwise indicate where the electrical feed is to be taken from.
- A23 Details are included in this Addenda 1.

- Q24 With regard to drawing MEP 1.1. Is there already a water supply to this building? Otherwise indicate where the water feed is to be taken from.
- A24 Details are included in this Addenda 1.
- Q25 With regard to drawing MEP 1.1. Is the fire protection stand alone or is it part of a wider site fire protection system.
- A25 Fire protection is being designed, details to follow.
- Q26 Is the old BELCO vault empty of BELCO equipment, or will there be a need to involve BELCO for equipment isolation and removal.
- A26 It will be empty of all electrical equipment. It has been made dead by BELCO.

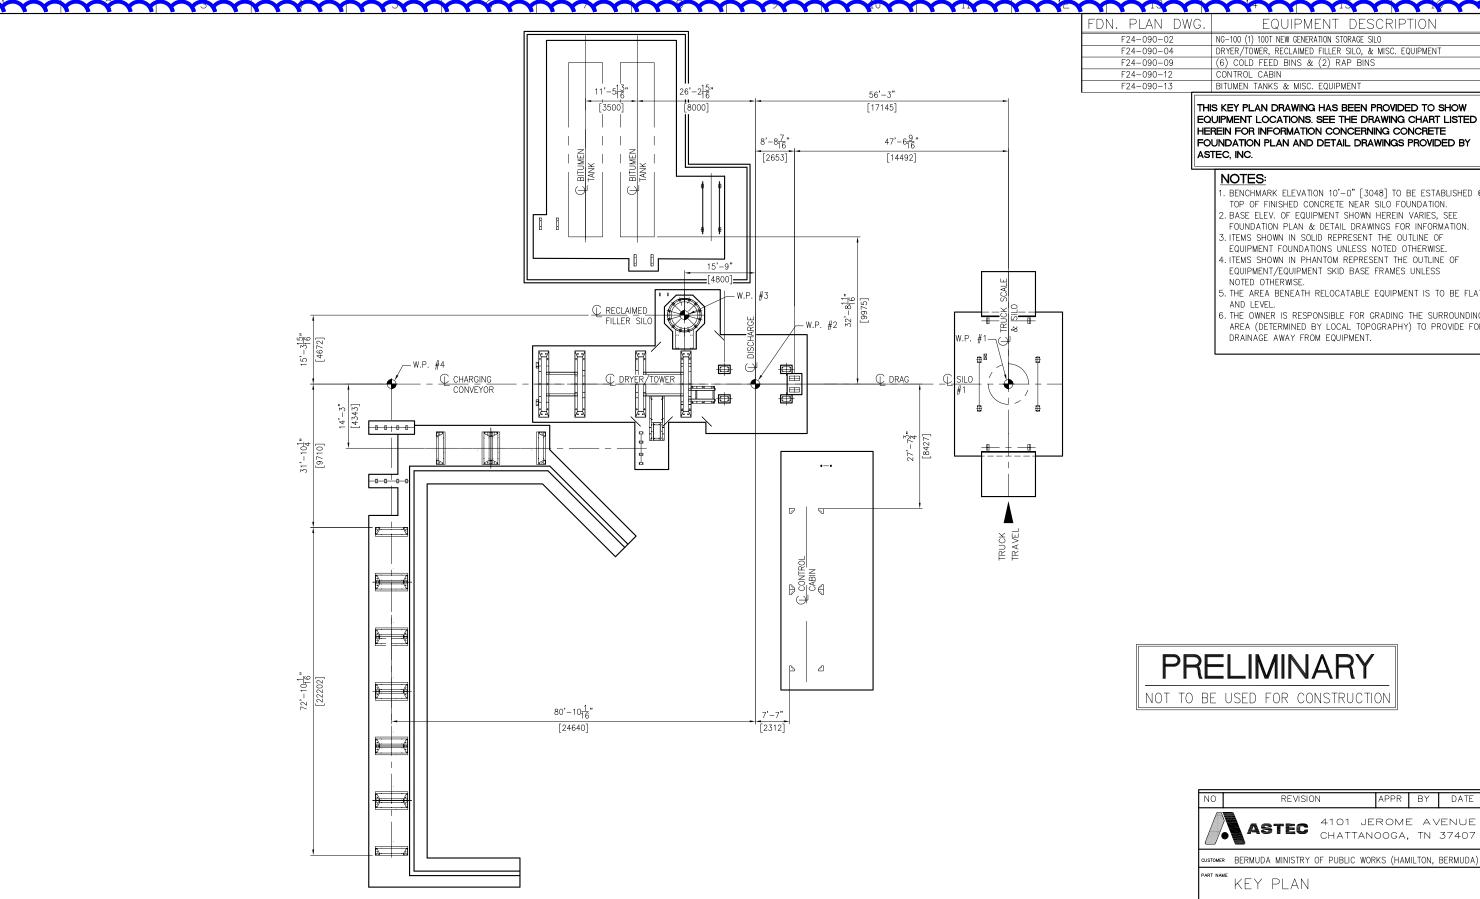

THIS KEY PLAN DRAWING HAS BEEN PROVIDED TO SHOW EQUIPMENT LOCATIONS. SEE THE DRAWING CHART LISTED HEREIN FOR INFORMATION CONCERNING CONCRETE FOUNDATION PLAN AND DETAIL DRAWINGS PROVIDED BY ASTEC, INC.


#### NOTES:

- 1. BENCHMARK ELEVATION 10'-0" [3048] TO BE ESTABLISHED @ TOP OF FINISHED CONCRETE NEAR SILO FOUNDATION.
- 2. BASE ELEV. OF EQUIPMENT SHOWN HEREIN VARIES, SEE FOUNDATION PLAN & DETAIL DRAWINGS FOR INFORMATION.
- 3. ITEMS SHOWN IN SOLID REPRESENT THE OUTLINE OF EQUIPMENT FOUNDATIONS UNLESS NOTED OTHERWISE.
- 4. ITEMS SHOWN IN PHANTOM REPRESENT THE OUTLINE OF EQUIPMENT/EQUIPMENT SKID BASE FRAMES UNLESS NOTED OTHERWISE.
- 5. THE AREA BENEATH RELOCATABLE EQUIPMENT IS TO BE FLAT AND LEVEL.
- 6. THE OWNER IS RESPONSIBLE FOR GRADING THE SURROUNDING AREA (DETERMINED BY LOCAL TOPOGRAPHY) TO PROVIDE FOR DRAINAGE AWAY FROM EQUIPMENT.



REVISION APPR BY DATE 4101 JEROME AVENUE CHATTANOOGA, TN 37407 USTOMER BERMUDA MINISTRY OF PUBLIC WORKS (HAMILTON, BERMUDA) KEY PLAN ACHINE DRYER/TOWER, RECLAIMED FILLER SILO, & MISC. EQUIPMENT

TOLERANCES ON DIMENSIONS UNLESS OTHERWISE NOTED ON THE DRAWING ARE: MACHINING  $(\pm 0.010'')$  - STRUCTURAL  $(\pm 1/8'')$  - WELD SIZE (-0'', +1/8''). THIS DRAWING AND THE DESIGN SHOWN THEREIN IS THE PROPERTY OF ASTEC, INC. AND USE OF COPIES THEREOF CANNOT BE MADE WITHOUT WRITTEN CONSENT

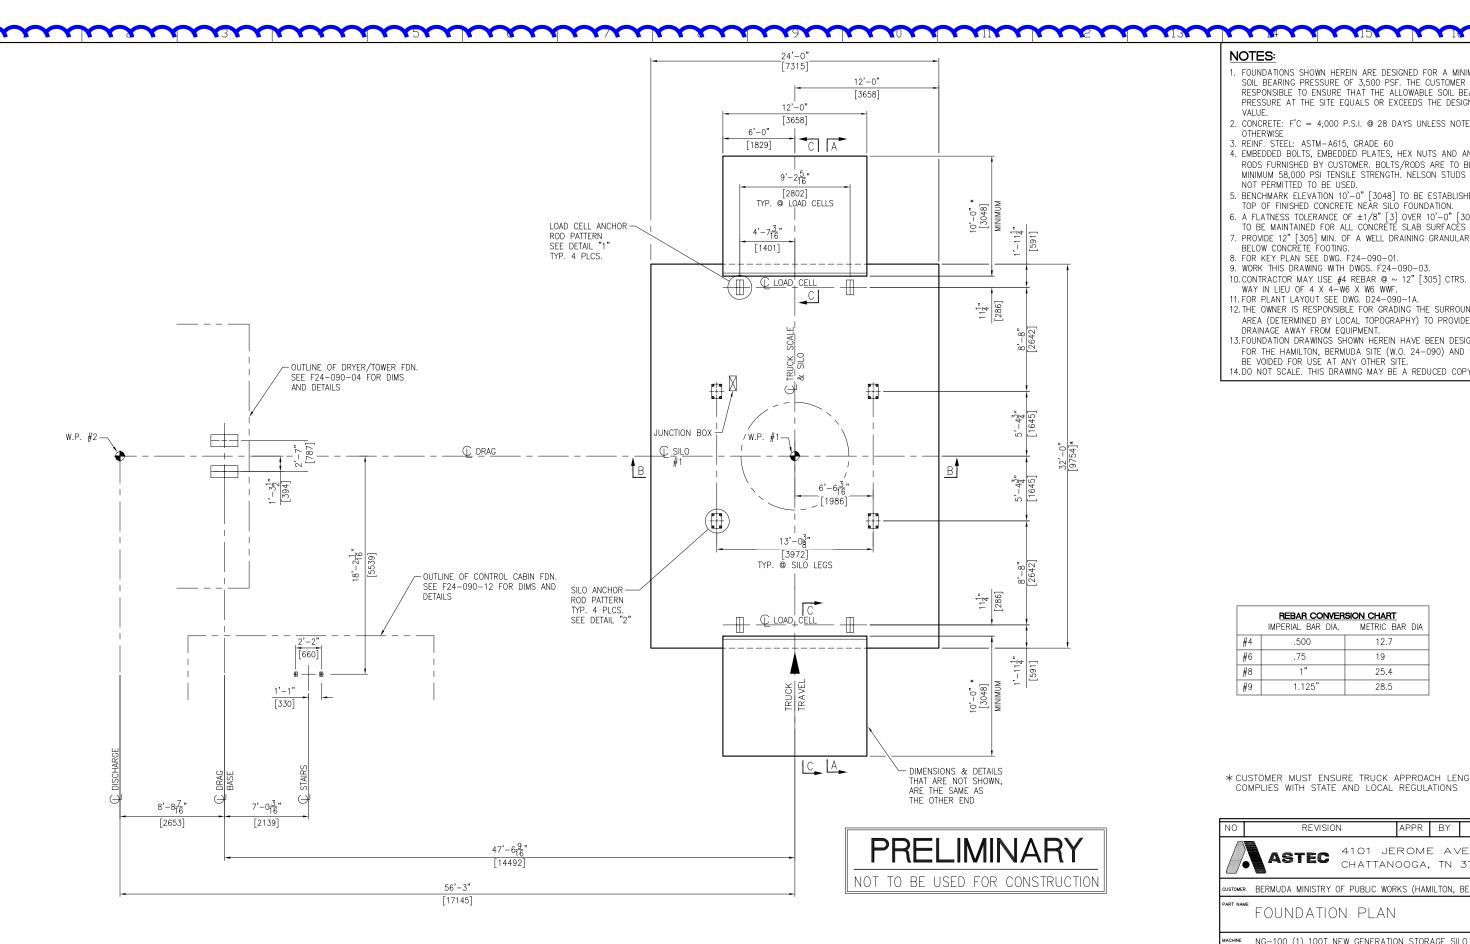

- 1. FOUNDATIONS SHOWN HEREIN ARE DESIGNED FOR A MINIMUM SOIL BEARING PRESSURE OF 3,500 PSF. THE CUSTOMER IS RESPONSIBLE TO ENSURE THAT THE ALLOWABLE SOIL BEARING PRESSURE AT THE SITE EQUALS OR EXCEEDS THE DESIGN
- 2. CONCRETE: F'C = 4,000 P.S.I. @ 28 DAYS UNLESS NOTED OTHERWISE
- OTHERWISE

  3. REINF. STEEL: ASTM-A615, GRADE 60

  4. EMBEDDED BOLTS, EMBEDDED PLATES, HEX NUTS AND ANCHOR RODS FURNISHED BY CUSTOMER. BOLTS/RODS ARE TO BE A MINIMUM 58,000 PSI TENSILE STRENGTH. NELSON STUDS ARE NOT PERMITTED TO BE USED.

- NOT PERMITTED TO BE USED.

  5. BENCHMARK ELEVATION 10'-0" [3048] TO BE ESTABLISHED © TOP OF FINISHED CONCRETE NEAR SILO FOUNDATION.

  6. A FLATNESS TOLERANCE OF ±1/8" [3] OVER 10'-0" [3048] IS TO BE MAINTAINED FOR ALL CONCRETE SLAB SURFACES

  7. PROVIDE 12" [305] MIN. OF A WELL DRAINING GRANULAR BASE BELOW CONCRETE FOOTING.
- 8. FOR KEY PLAN SEE DWG. F24-090-01.
- 9. WORK THIS DRAWING WITH DWGS. F24-090-03.
- 10.CONTRACTOR MAY USE #4 REBAR @ ~ 12" [305] CTRS. EACH WAY IN LIEU OF 4 X 4-W6 X W6 WWF.
- 11. FOR PLANT LAYOUT SEE DWG. D24-090-1A.
- 12. THE OWNER IS RESPONSIBLE FOR GRADING THE SURROUNDING AREA (DETERMINED BY LOCAL TOPOGRAPHY) TO PROVIDE FOR DRAINÀGE AWAY FROM EQUIPMENT.
- 13. FOUNDATION DRAWINGS SHOWN HEREIN HAVE BEEN DESIGNED FOR THE HAMILTON, BERMUDA SITE (W.O. 24-090) AND SHALL BE VOIDED FOR USE AT ANY OTHER SITE.


  14.DO NOT SCALE. THIS DRAWING MAY BE A REDUCED COPY.


REBAR CONVERSION CHART				
	IMPERIAL BAR DIA.	METRIC BAR DIA		
#4	.500	12.7		
#6	.75	19		
#8	1"	25.4		
#9	1.125"	28.5		


\* CUSTOMER MUST ENSURE TRUCK APPROACH LENGTH COMPLIES WITH STATE AND LOCAL REGULATIONS

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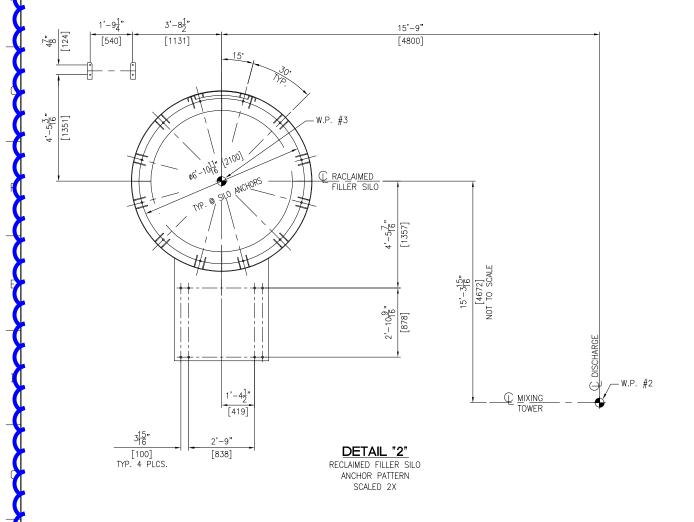
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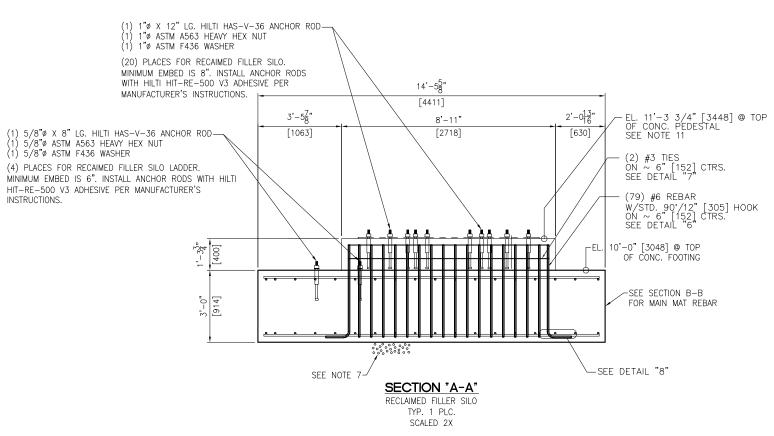





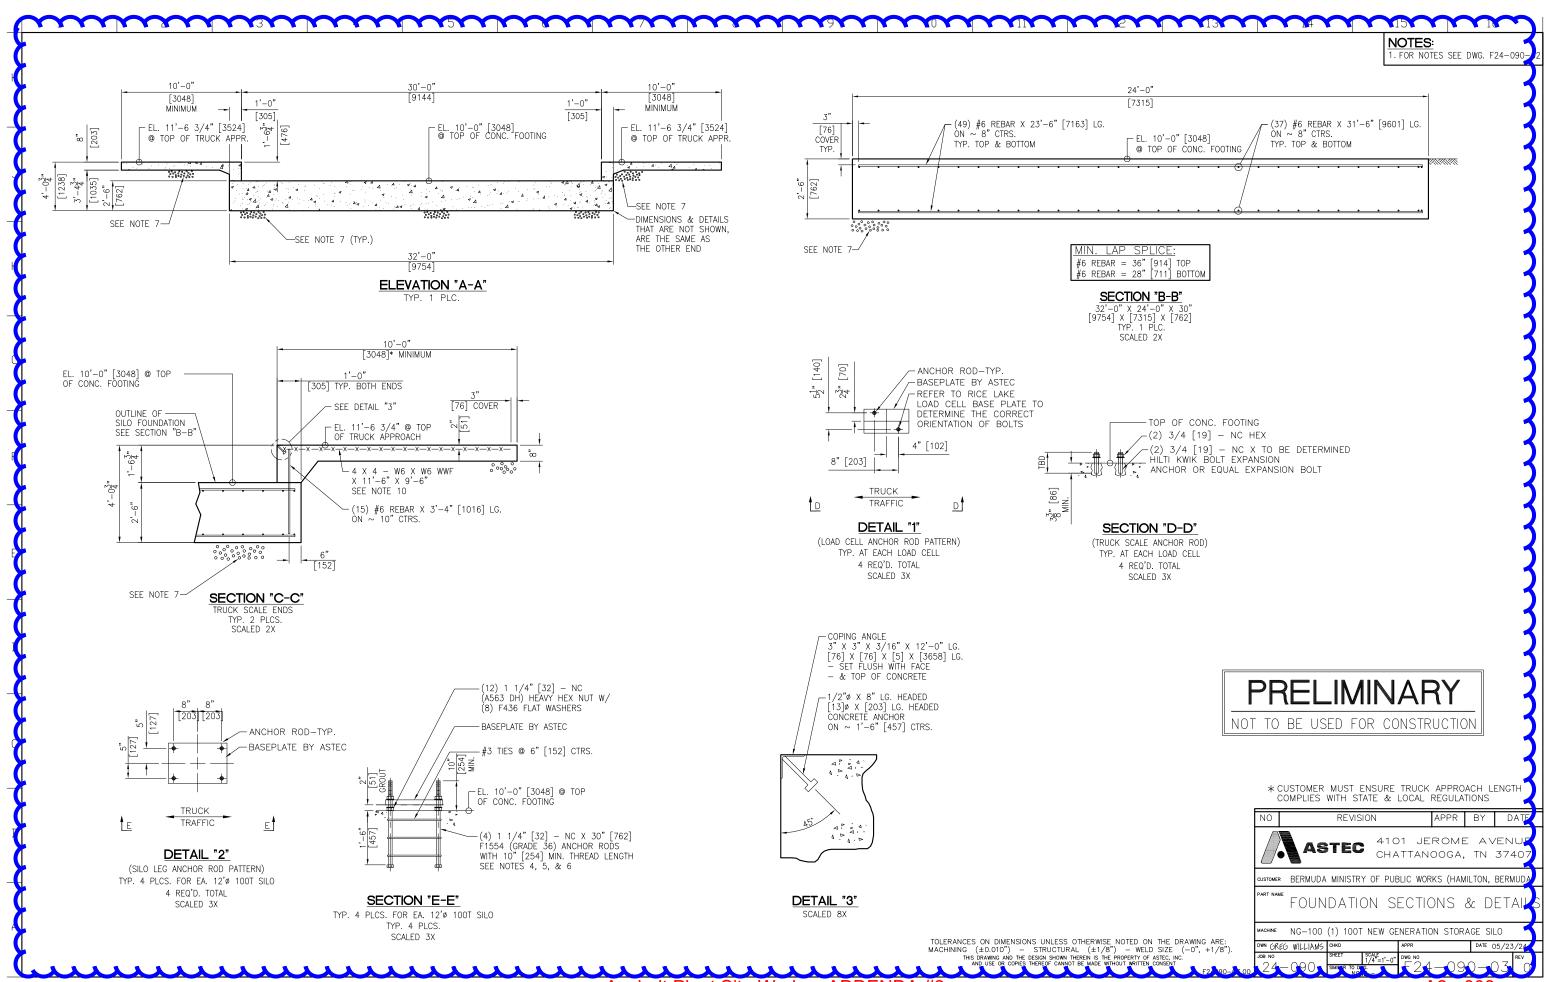

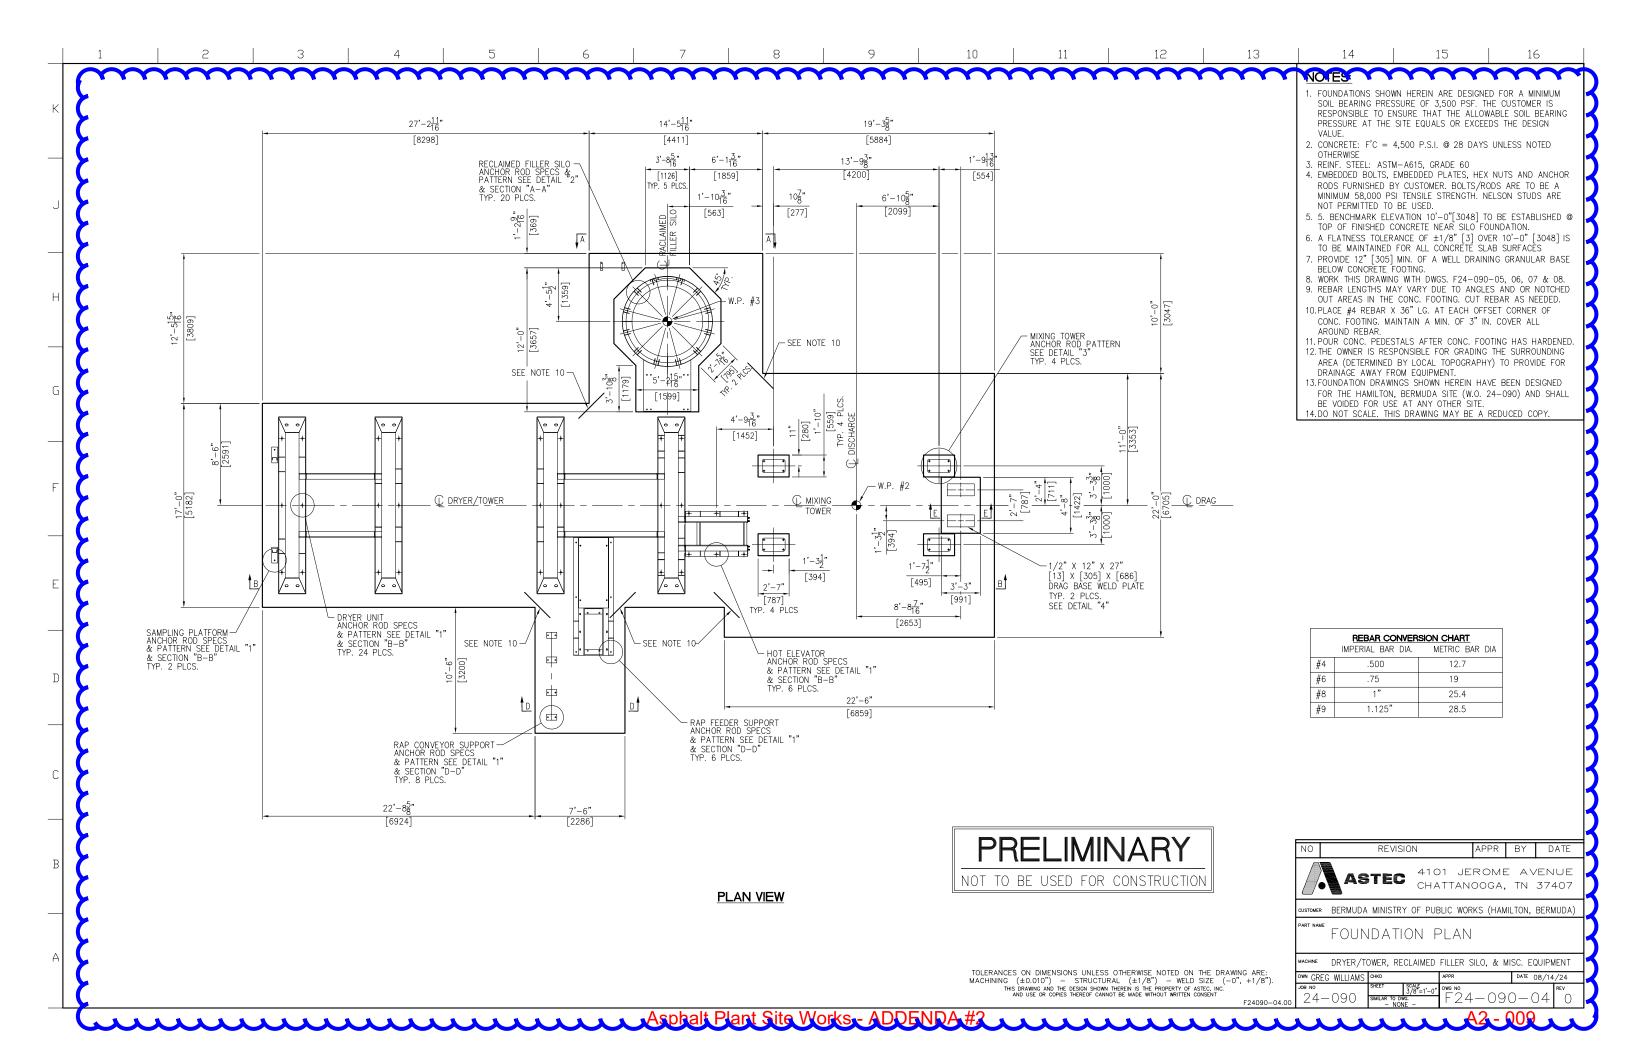NOTES:
1. FOR NOTES SEE DWG. F24-090-04

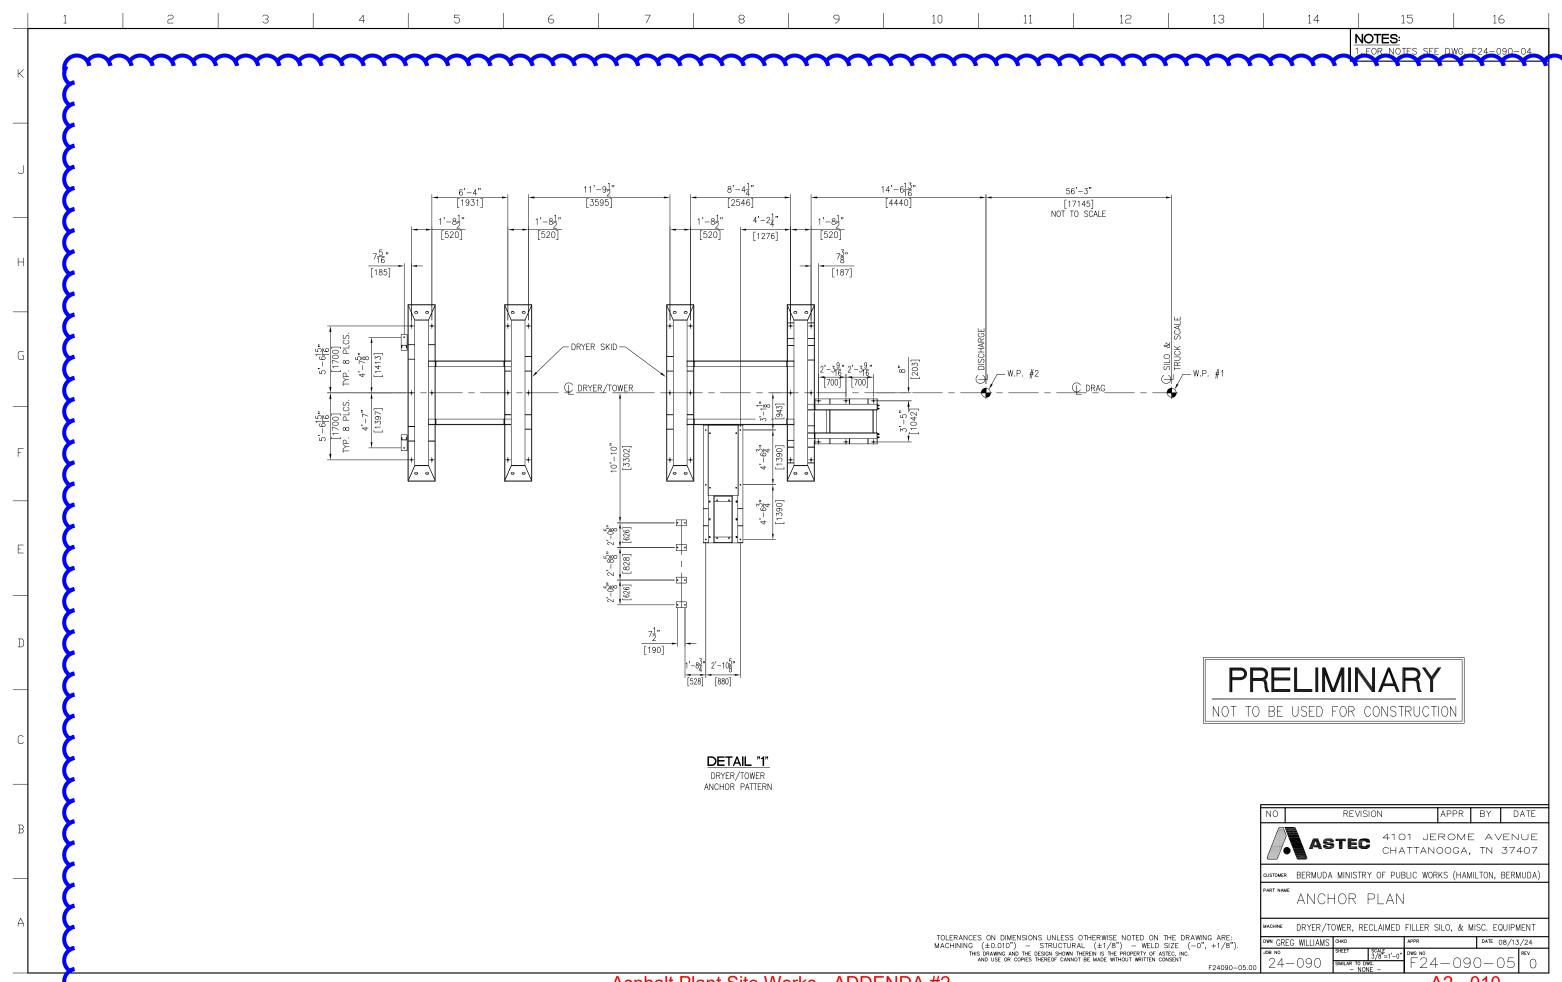



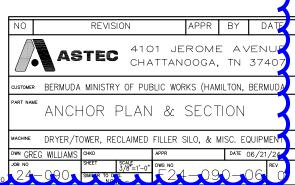



**PRELIMINARY** 


NOT TO BE USED FOR CONSTRUCTION

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  6. A FLATNESS TOLERANCE OF ±1/8" [3] OVER 10'-0" [3048] TO BE MAINTAINED FOR ALL CONCRETE SLAB SURFACES
- 7. PROVIDE 12" [305] MIN. OF A WELL DRAINING GRANULAR BASI BELOW CONCRETE FOOTING.
- 8. WORK THIS DRAWING WITH DWGS. F24-090-10 & 11.
- 9. POUR CONCRETE RETAINING WALL AFTER CONCRETE FOOTING HAS HARDENED.
- 10. REBAR LENGTHS MAY VARY DUE TO ANGLES AND OR NOTCHED OUT AREAS IN THE CONC. FOOTING. CUT REBAR AS NEEDED. 11. PROVIDE CONTROL JOINTS @  $\sim$  10' SPACINGS.
- 12.DO NOT PLACE RETAINING WALL WEEP HOLES NEAR OR AROUNE EQUIPMENT LEGS. EQUIPMENT LEGS OR ANY OTHER OBJECTS
- LOCATED IN THE RUNOFF PATH MAY CAUSE GRAVEL BUILD UP AND OR DRAIN CLOGGING. 13. THE OWNER IS RESPONSIBLE FOR GRADING THE SURROUNDING AREA (DETERMINED BY LOCAL TOPOGRAPHY) TO PROVIDE FOR
- DRAINÀGE AWAY FROM EQUIPMENT. 14. FOUNDATION DRAWINGS SHOWN HEREIN HAVE BEEN DESIGNED FOR THE HAMILTON, BERMUDA SITE (W.O. 24-090) AND SHALL BE VOIDED FOR USE AT ANY OTHER SITE.


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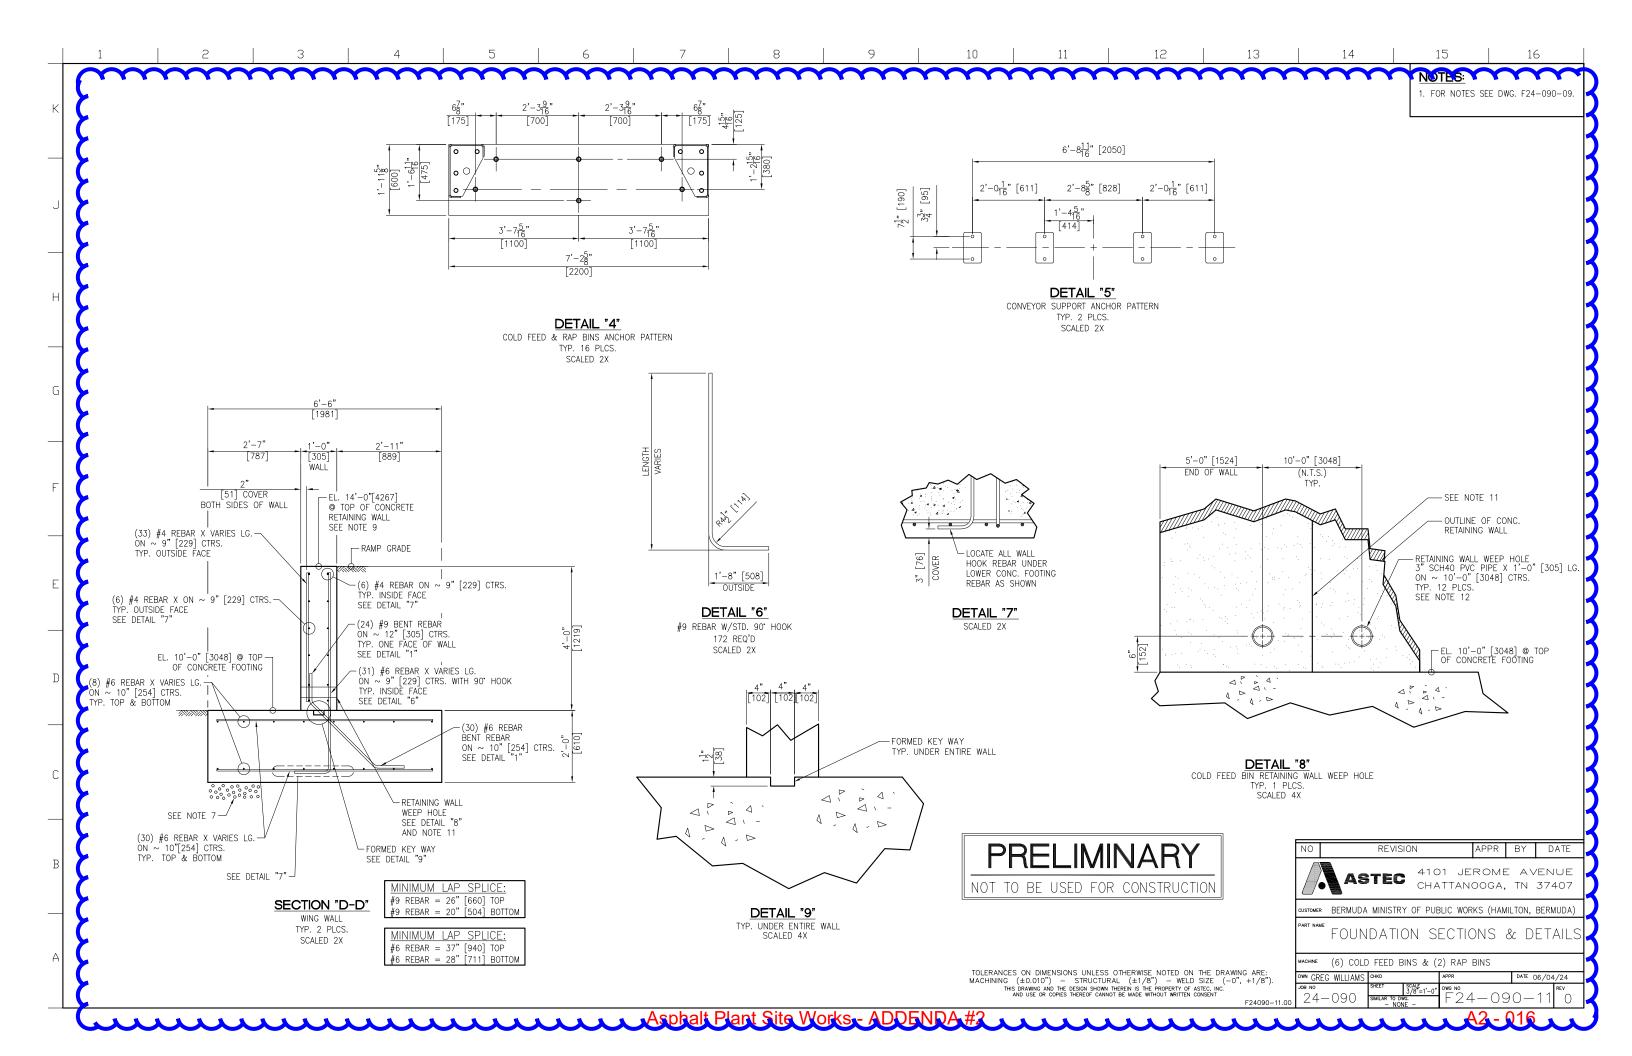
	<u>श्र</u>
IMPERIAL BAR DIA. METRIC	BAR DIA
#4 .500 12.	7
#6 .75 19	
#8 1" 25.·	4
#9 1.125" 28.5	5

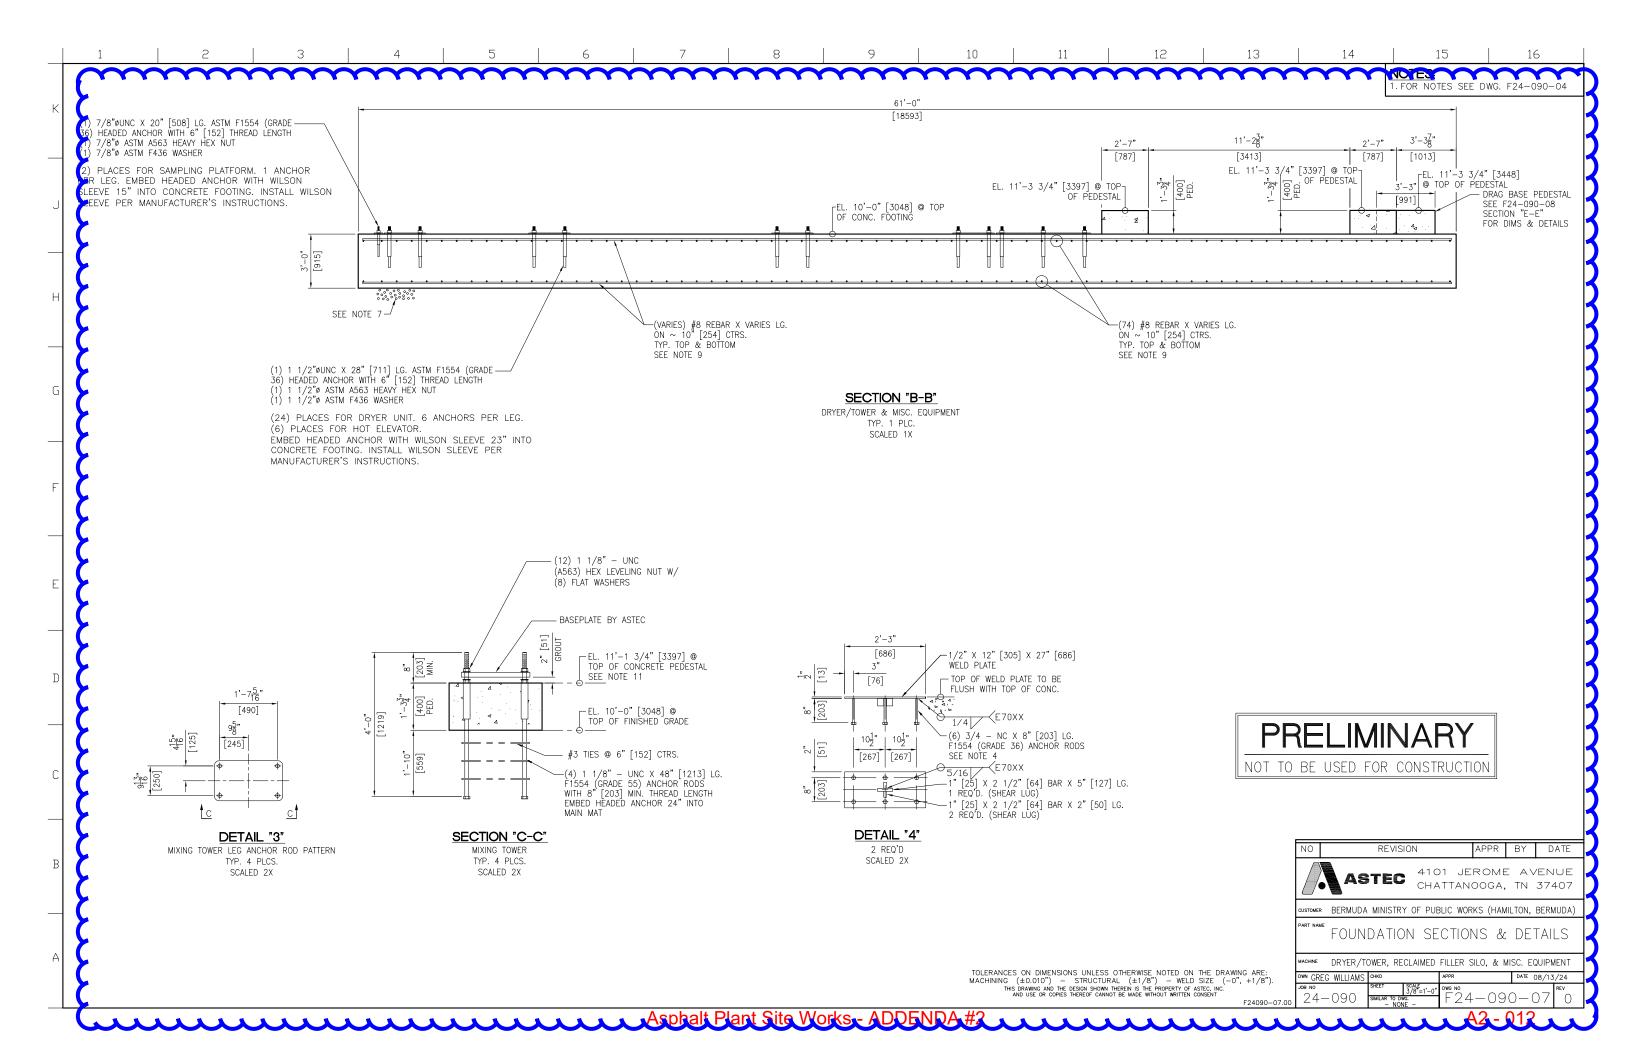
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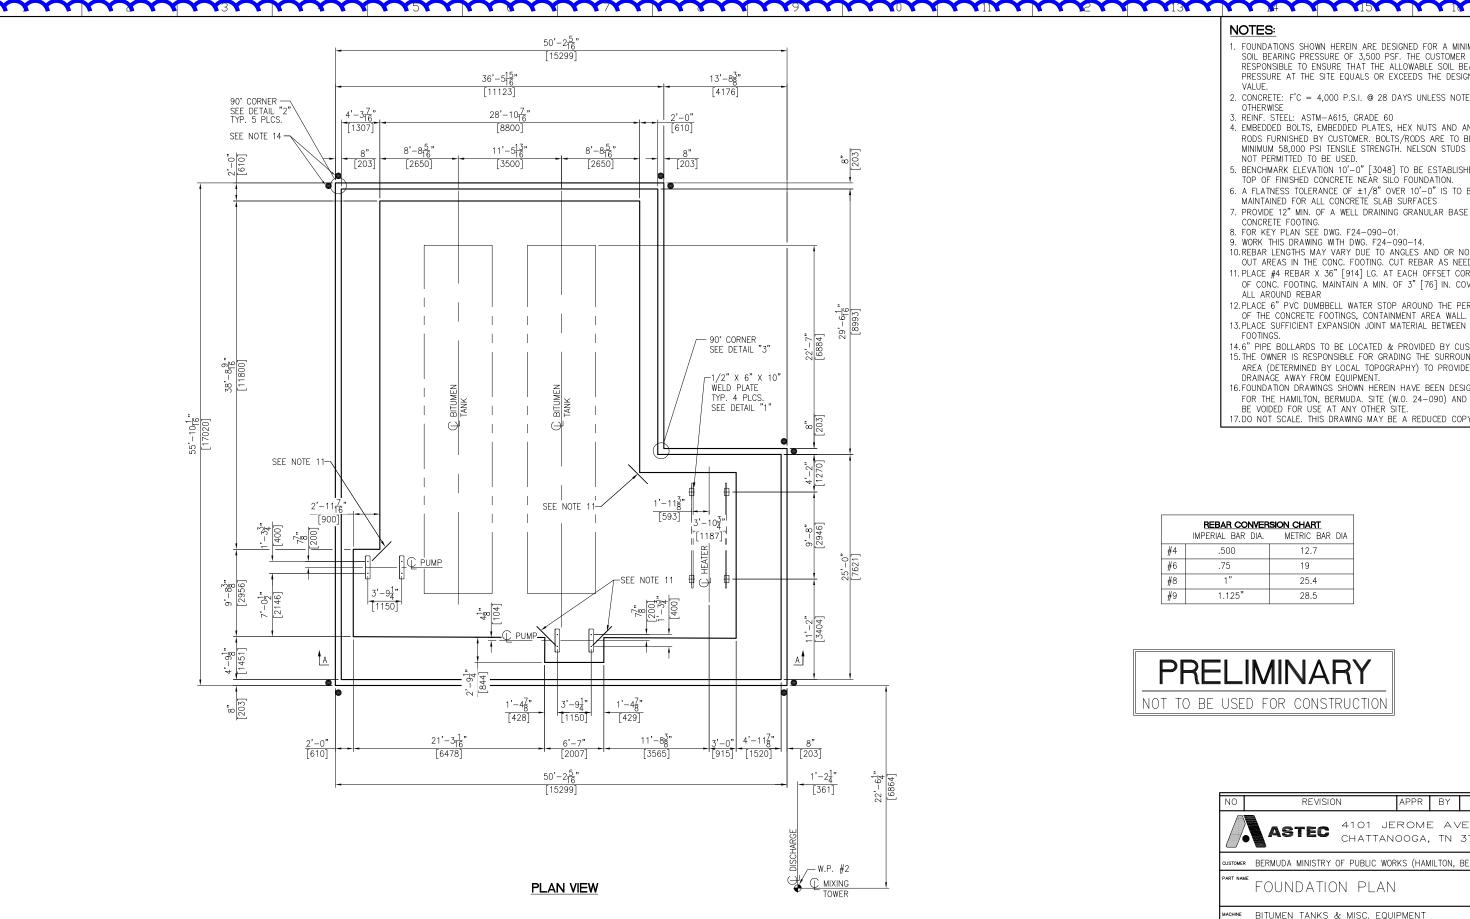
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REVISION APPR BY DATE 4101 JEROME AVENU CHATTANOOGA, TN 37407 USTOMER BERMUDA MINISTRY OF PUBLIC WORKS (HAMILTON, BERMUD) FOUNDATION PLAN ACHINE (6) COLD FEED BINS & (2) RAP BINS DWN GREG WILLIAMS CHKE

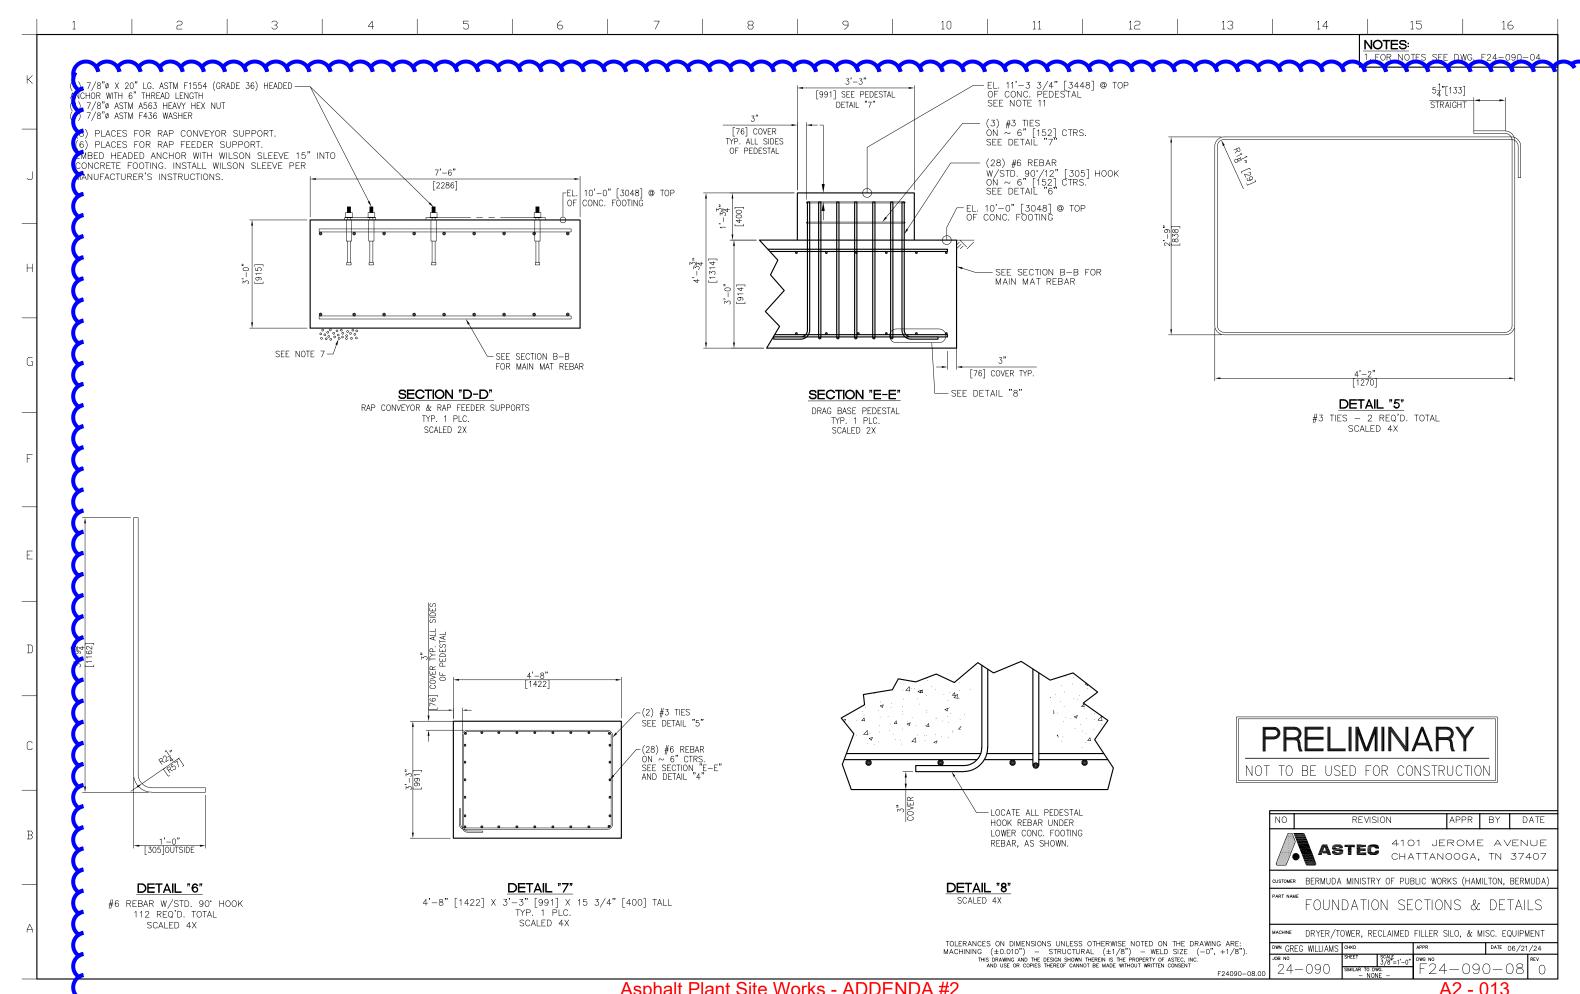

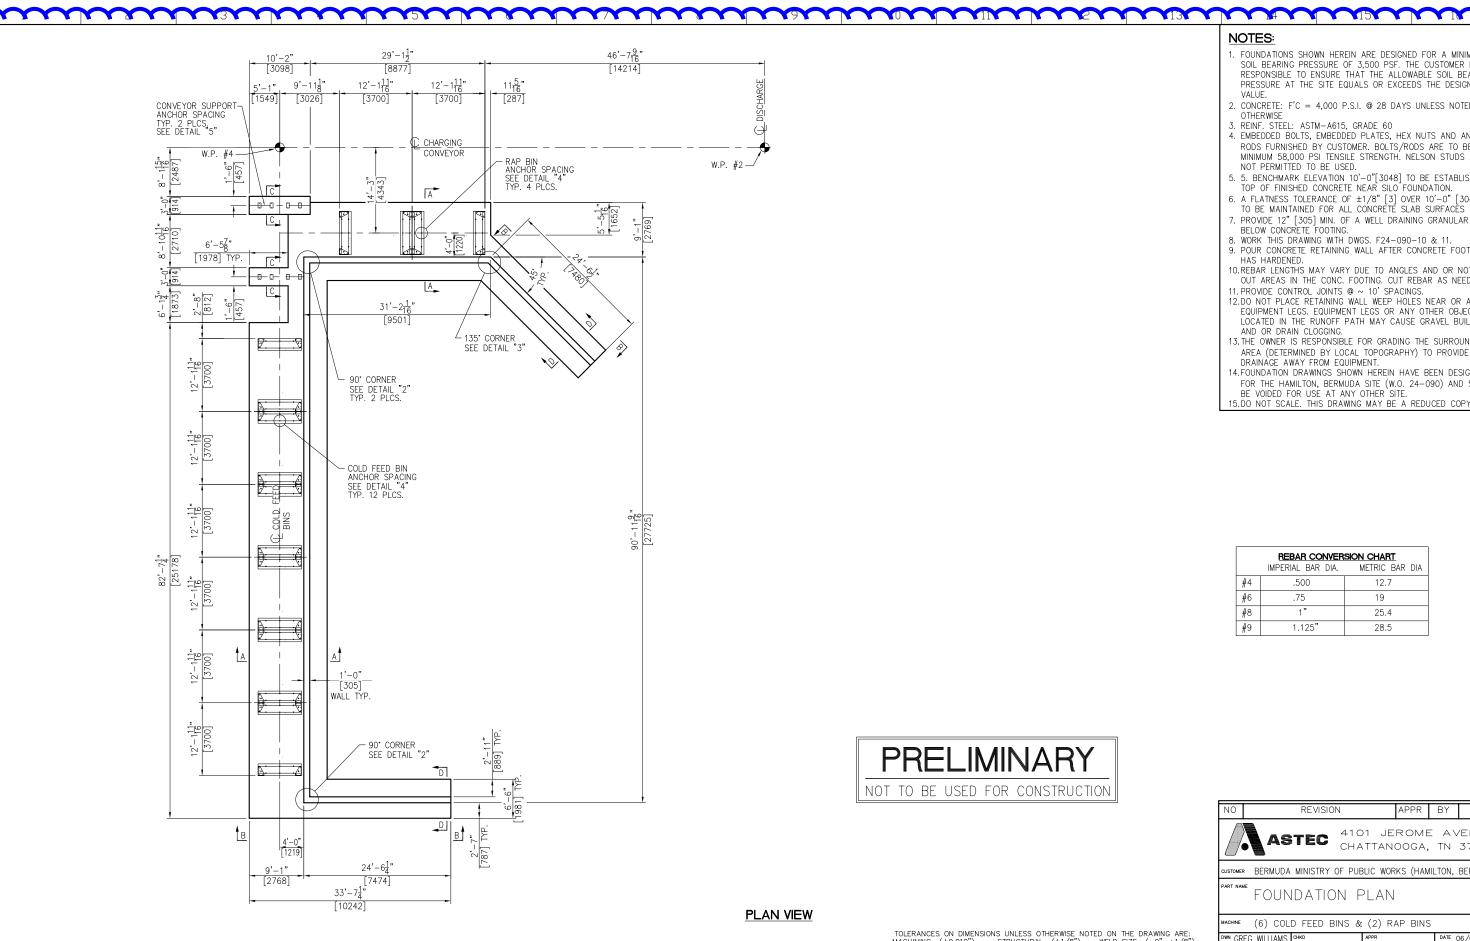



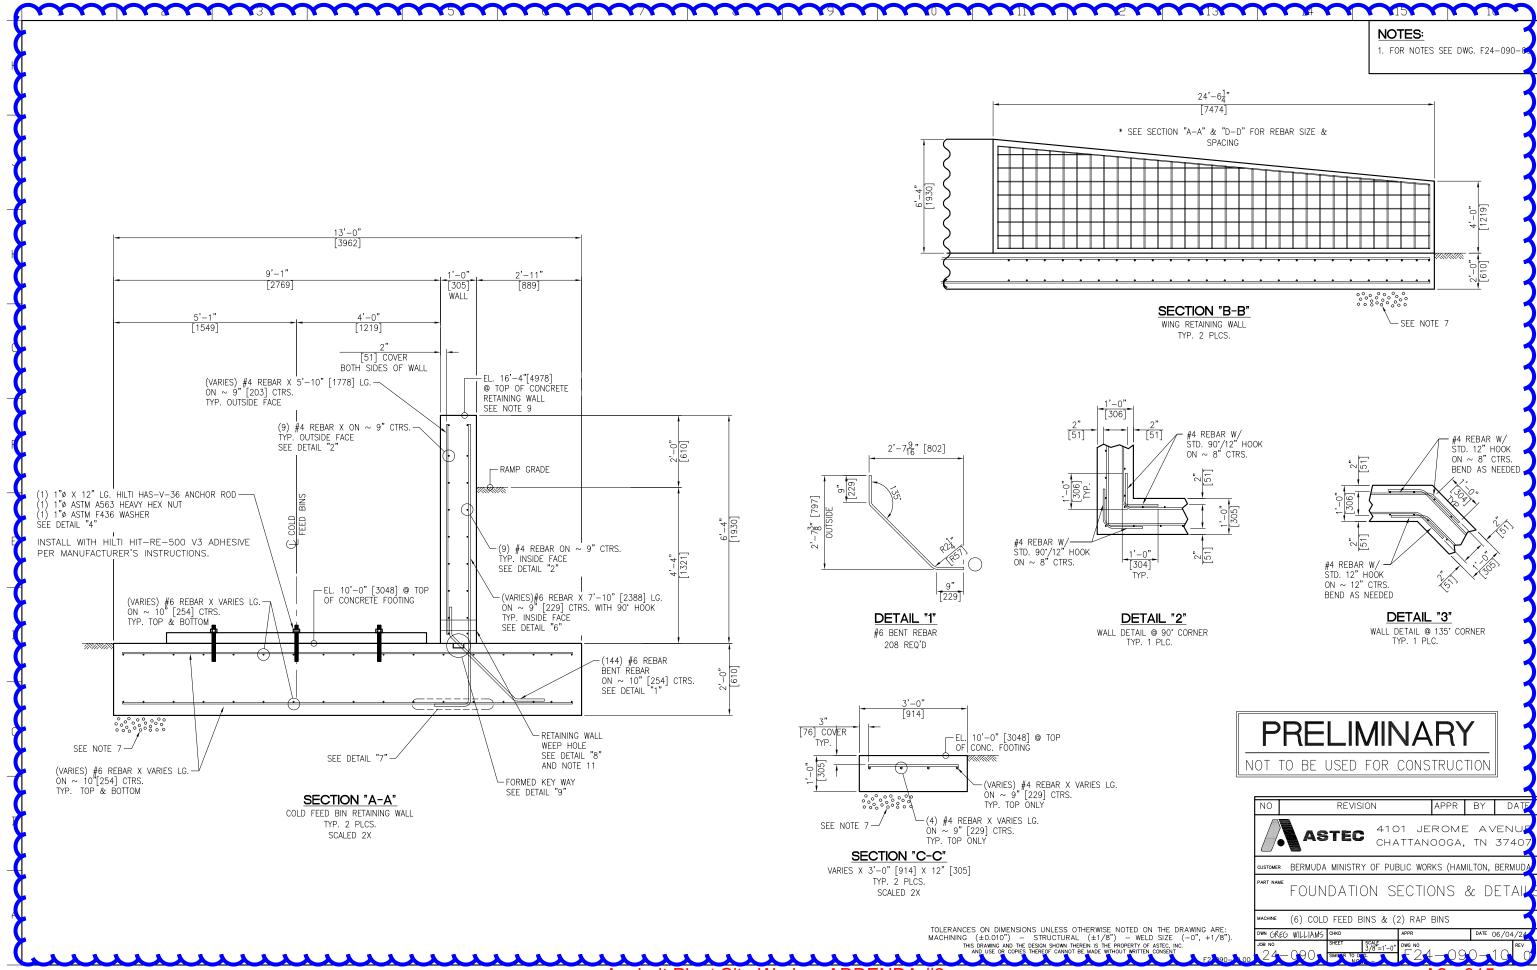
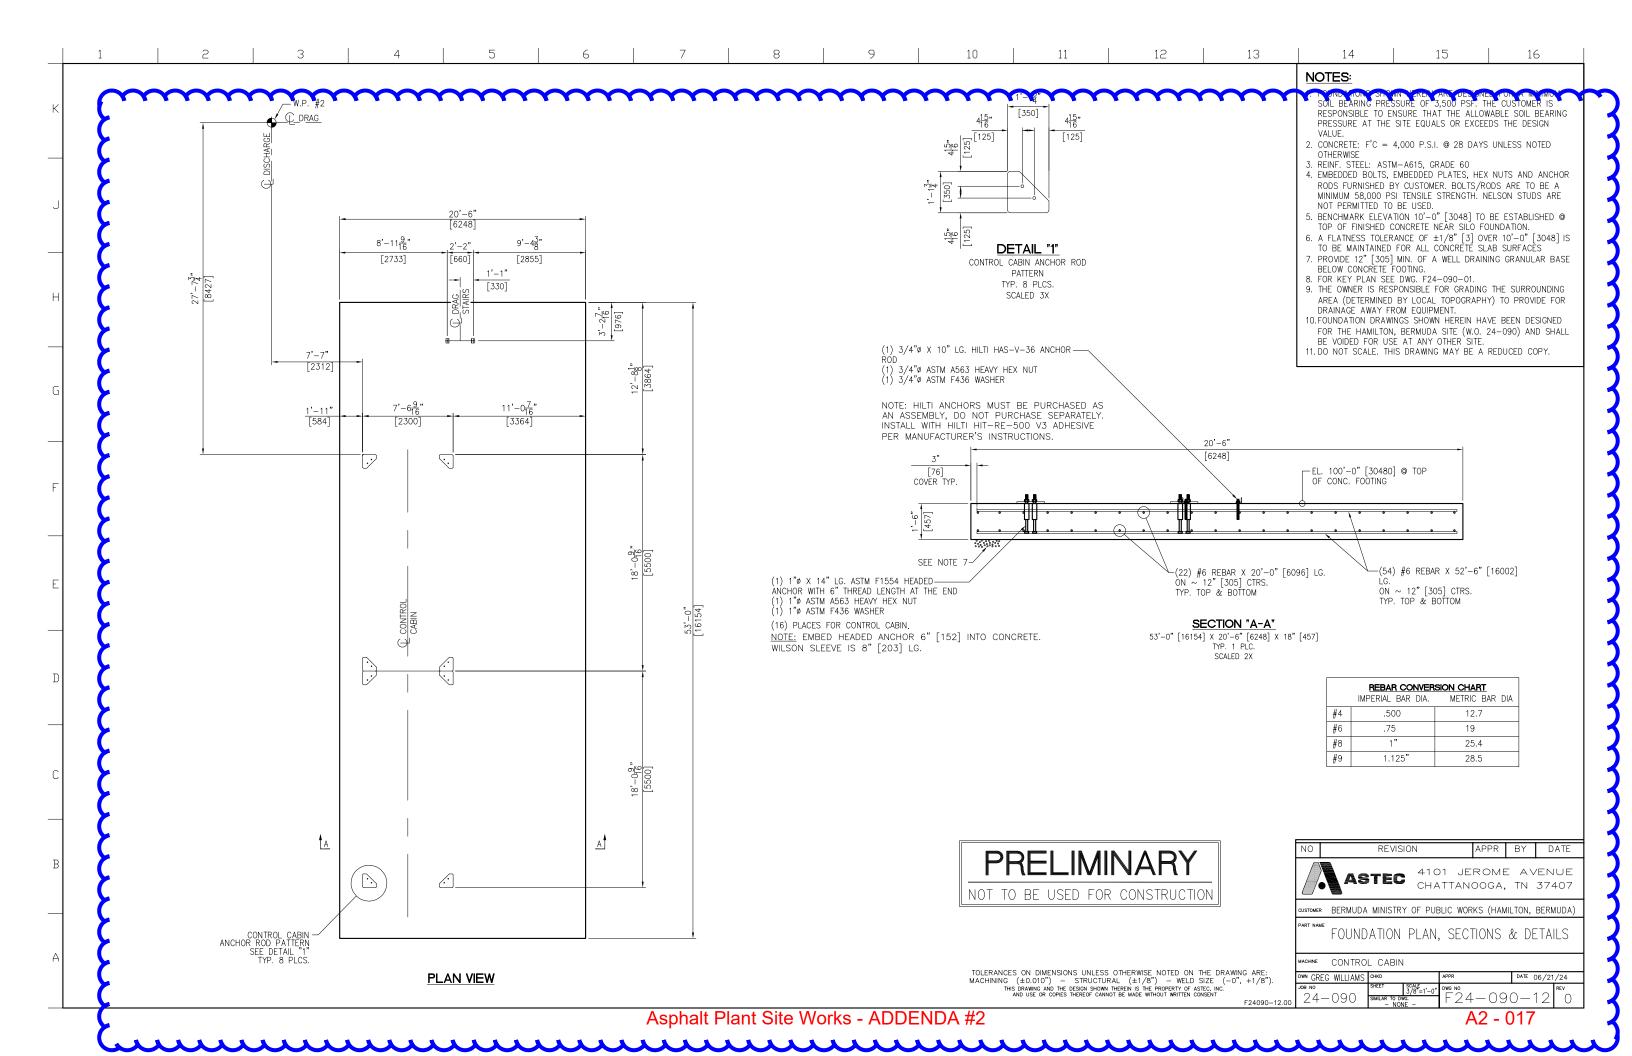
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- 8. FOR KEY PLAN SEE DWG. F24-090-01.
- 9. WORK THIS DRAWING WITH DWG. F24-090-14.
- 10. REBAR LENGTHS MAY VARY DUE TO ANGLES AND OR NOTCHED OUT AREAS IN THE CONC. FOOTING. CUT REBAR AS NEEDED.
- 11. PLACE #4 REBAR X 36" [914] LG. AT EACH OFFSET CORNER OF CONC. FOOTING. MAINTAIN A MIN. OF 3" [76] IN. COVER ALL AROUND REBAR
- 12.PLACE 6" PVC DUMBBELL WATER STOP AROUND THE PERIMETER OF THE CONCRETE FOOTINGS, CONTAINMENT AREA WALL.
- 13. PLACE SUFFICIENT EXPANSION JOINT MATERIAL BETWEEN FOOTINGS.
- 14.6" PIPE BOLLARDS TO BE LOCATED & PROVIDED BY CUSTOMER 15.THE OWNER IS RESPONSIBLE FOR GRADING THE SURROUNDING AREA (DETERMINED BY LOCAL TOPOGRAPHY) TO PROVIDE FOR DRAINÀGE AWAY FROM EQUIPMENT.
- 16. FOUNDATION DRAWINGS SHOWN HEREIN HAVE BEEN DESIGNED FOR THE HAMILTON, BERMUDA. SITE (W.O. 24-090) AND SHALL BE VOIDED FOR USE AT ANY OTHER SITE.


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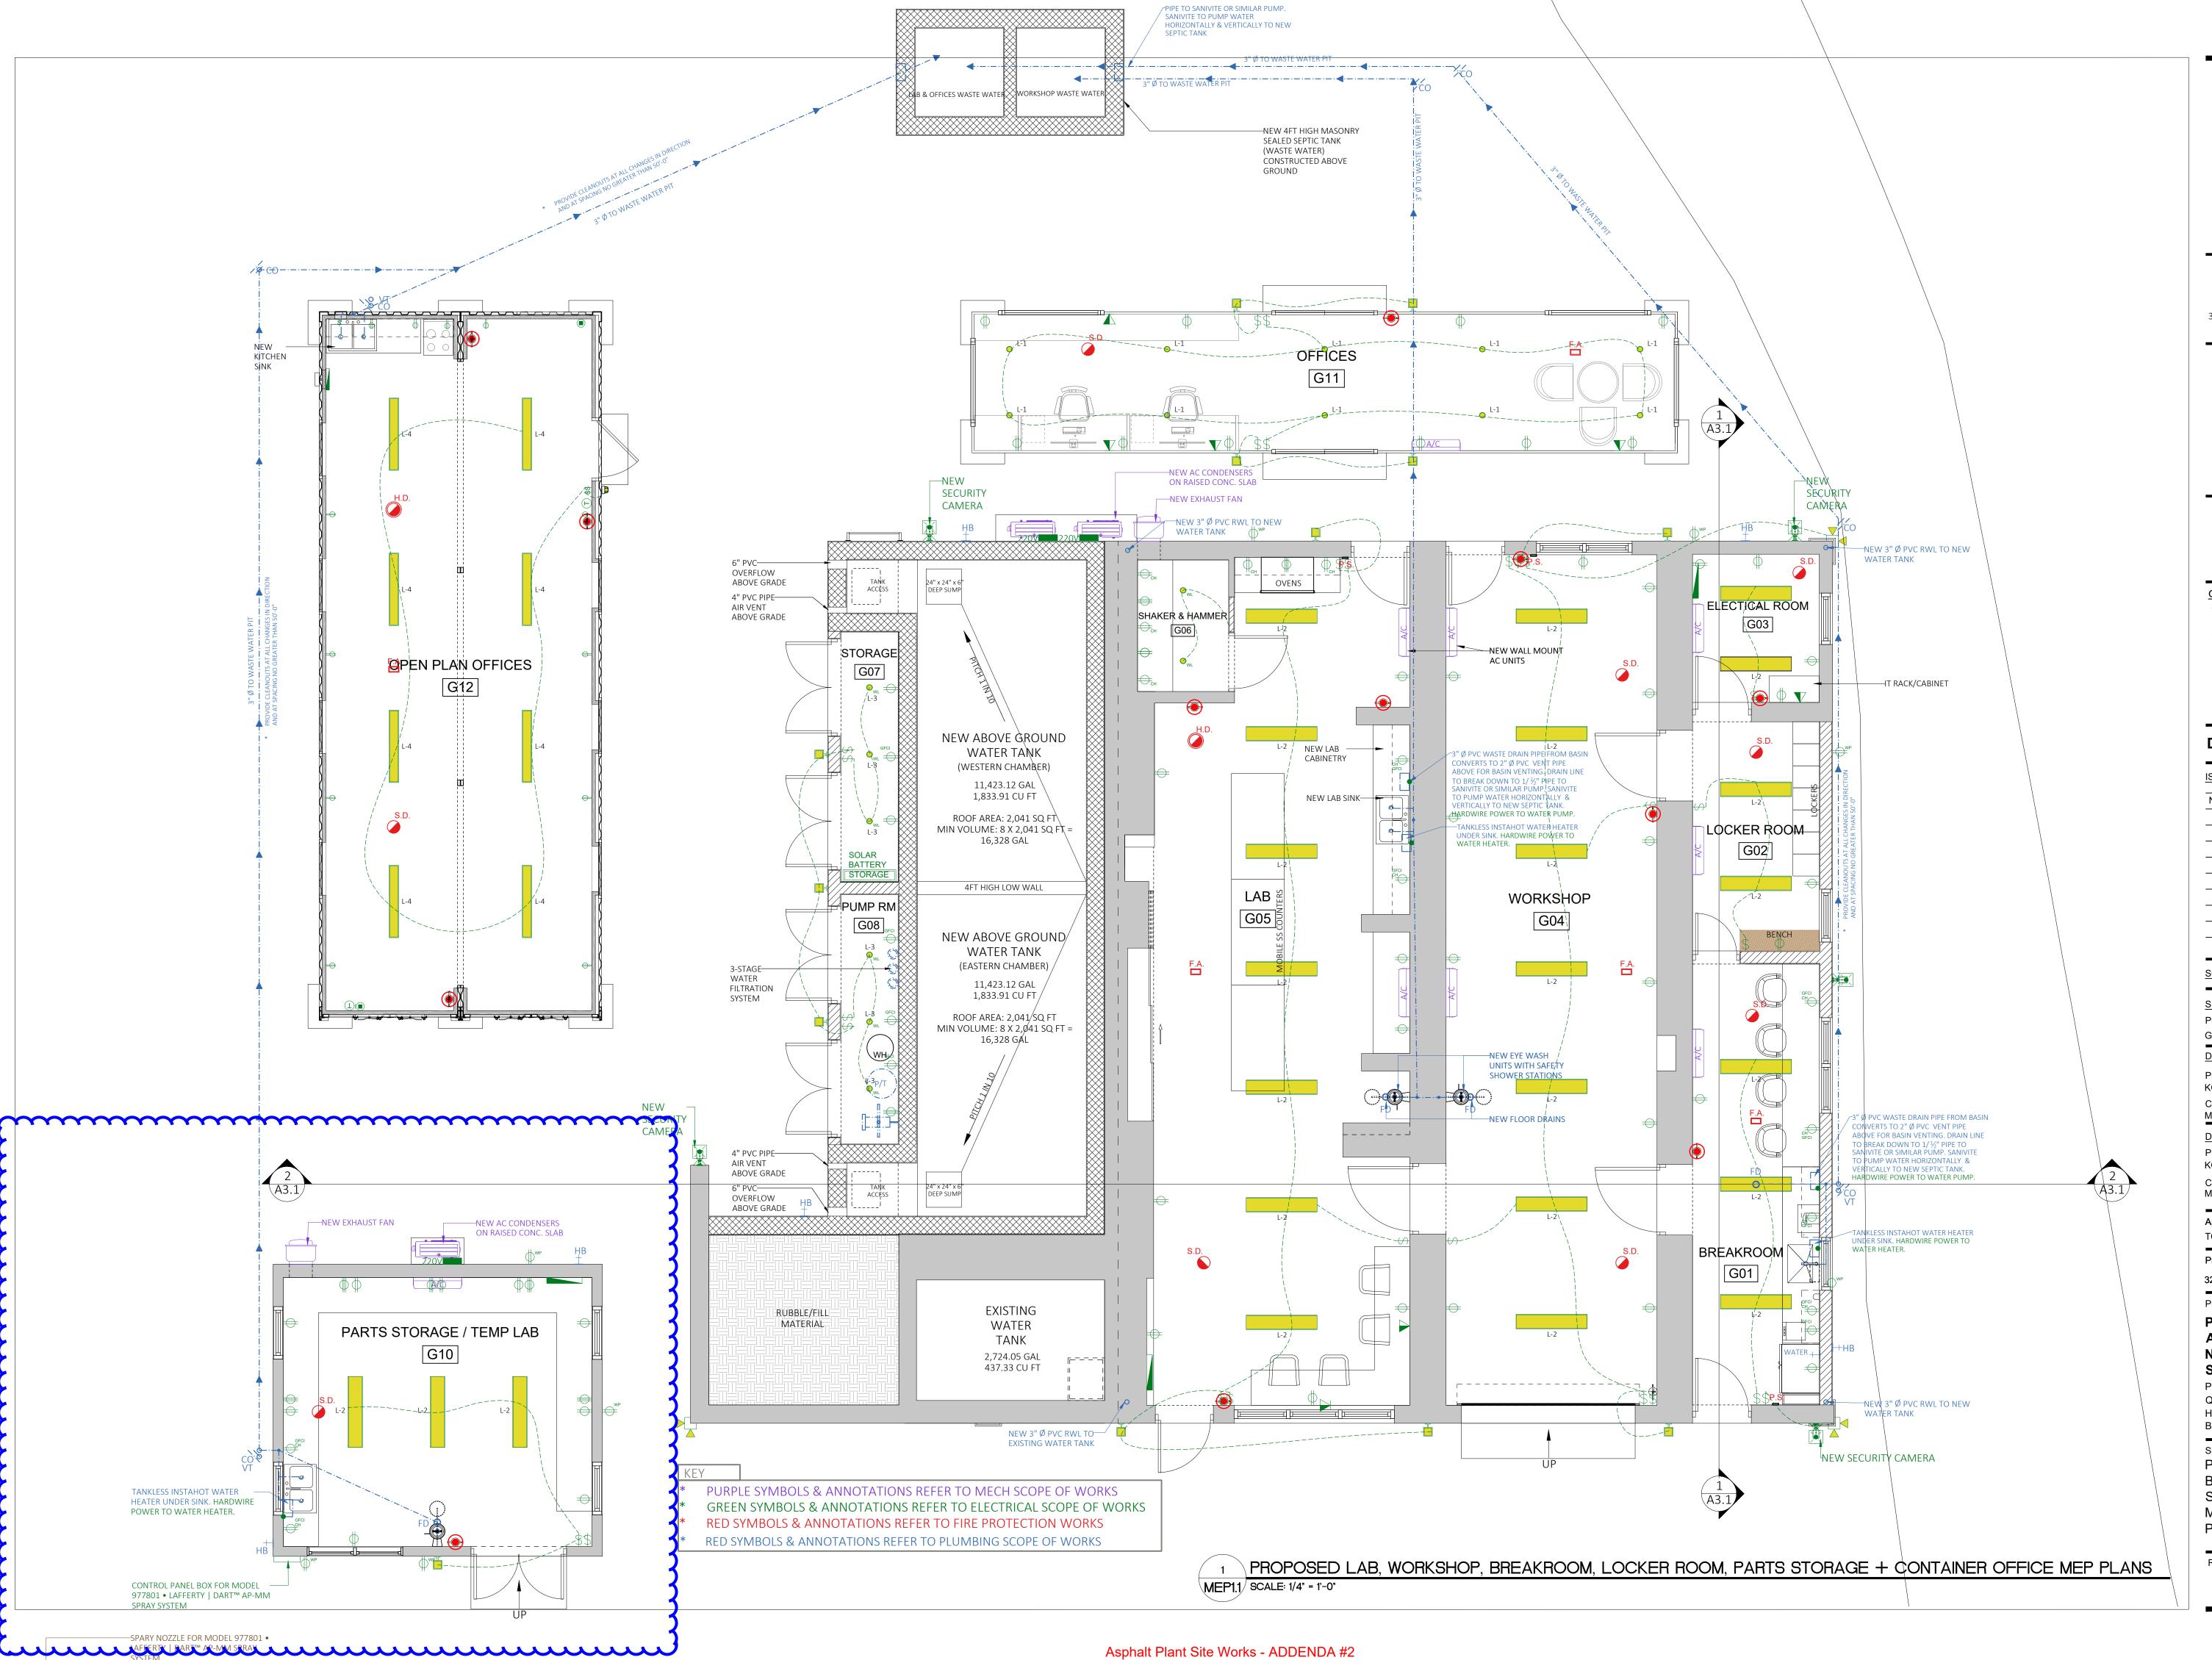
REBAR CONVERSION CHART			
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MINISTRY OF PUBLIC WORKS




# DEPARTMENT OF WORKS AND ENGINEERING

Government Administration Building, 3rd Floor | 56 Church Street | Hamilton, Bermuda HM12

Tel: (441) 501-3005

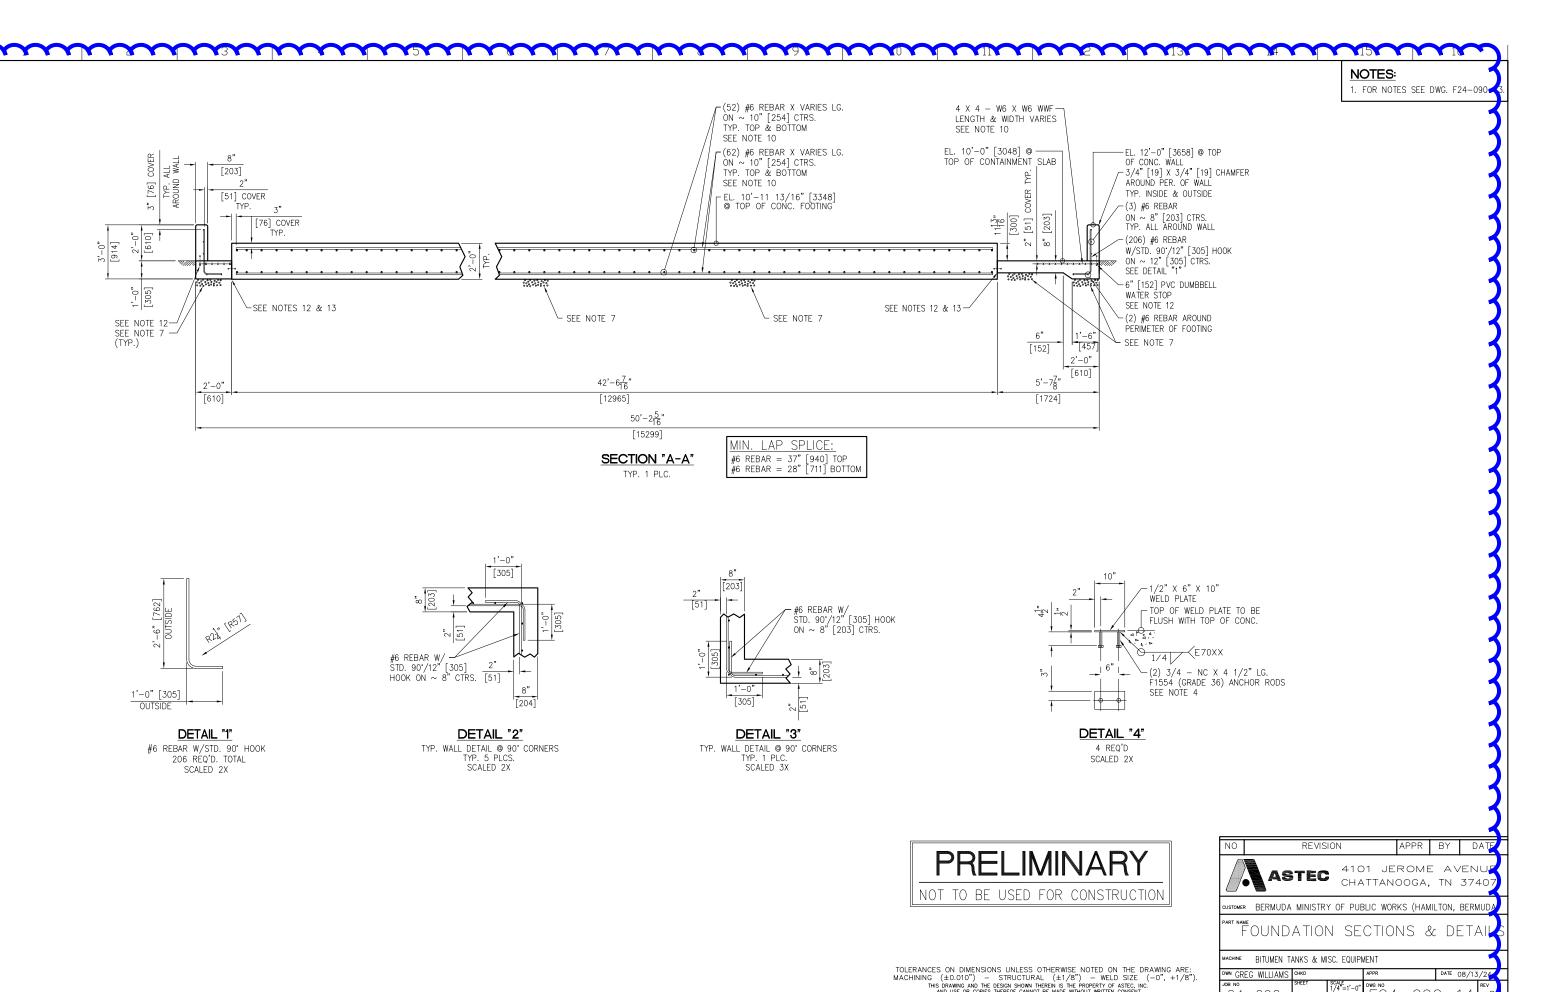

P.O. Box HM 428, Hamilton, Bermuda HM BX Tel: +1 441 707 0700 Email: info@brickverde.com Web: www.brickverde.com

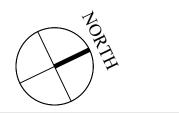

#### **GENERAL NOTES**

- 1. DO NOT SCALE THE DRAWINGS
- 2. THE CONTRACTOR SHALL VERIFY ALL DIMENSIONS ON SITE AND REPORT ANY DISCREPANCIES TO THE OWNERS REPRESENTATIVE BEFORE PROCEEDING WITH THE WORKS.

## **DAP 1 APPLICATION DRAWINGS**

# ISSUE / REVISION No. Date: 1 Issued for DAP 1 Submission 22 Jul 2024 2 Issued for DAP 1 Submission 26 Jul 2024 3 Issued for Tender 13 Aug 2024 4 Issued for Tender 19 Aug 2024

SCALE: 1/4" = 1'-0"	
SURVEY Prepared By: GOVERNMENT LAND SURVEY DEPT	Date:
DESIGN	
Prepared By: KGW	Date: 15/05/202
Checked By:	Date:

Date:

MM 15/05/2024

DRAWING

Prepared By: Date:

KGW 15/05/2024

Checked By: Date:

MM 15/05/2024

#### Approved By: TC

Project Number: Brick Verde Ref Number: 32/23/200 240219AP

Project Title:

PROPOSED ASPHALT PLANT, AGGREGATE SCREENING PLANT, NEW WORKSHOP, LAB AND SITE SERVICES


PUBLIC WORKS QUARRY & DEPOT QUARRY ROAD HAMILTON PARISH BERMUDA

Sheet Title:

PROPOSED LAB, WORKSHOP, BREAKROOM, LOCKER ROOM, PARTS STORAGE & CONTAINER OFFICE MECHANICAL, ELECTRICAL, PLUMBING

Revisions:

Sheet Number: MEP1.

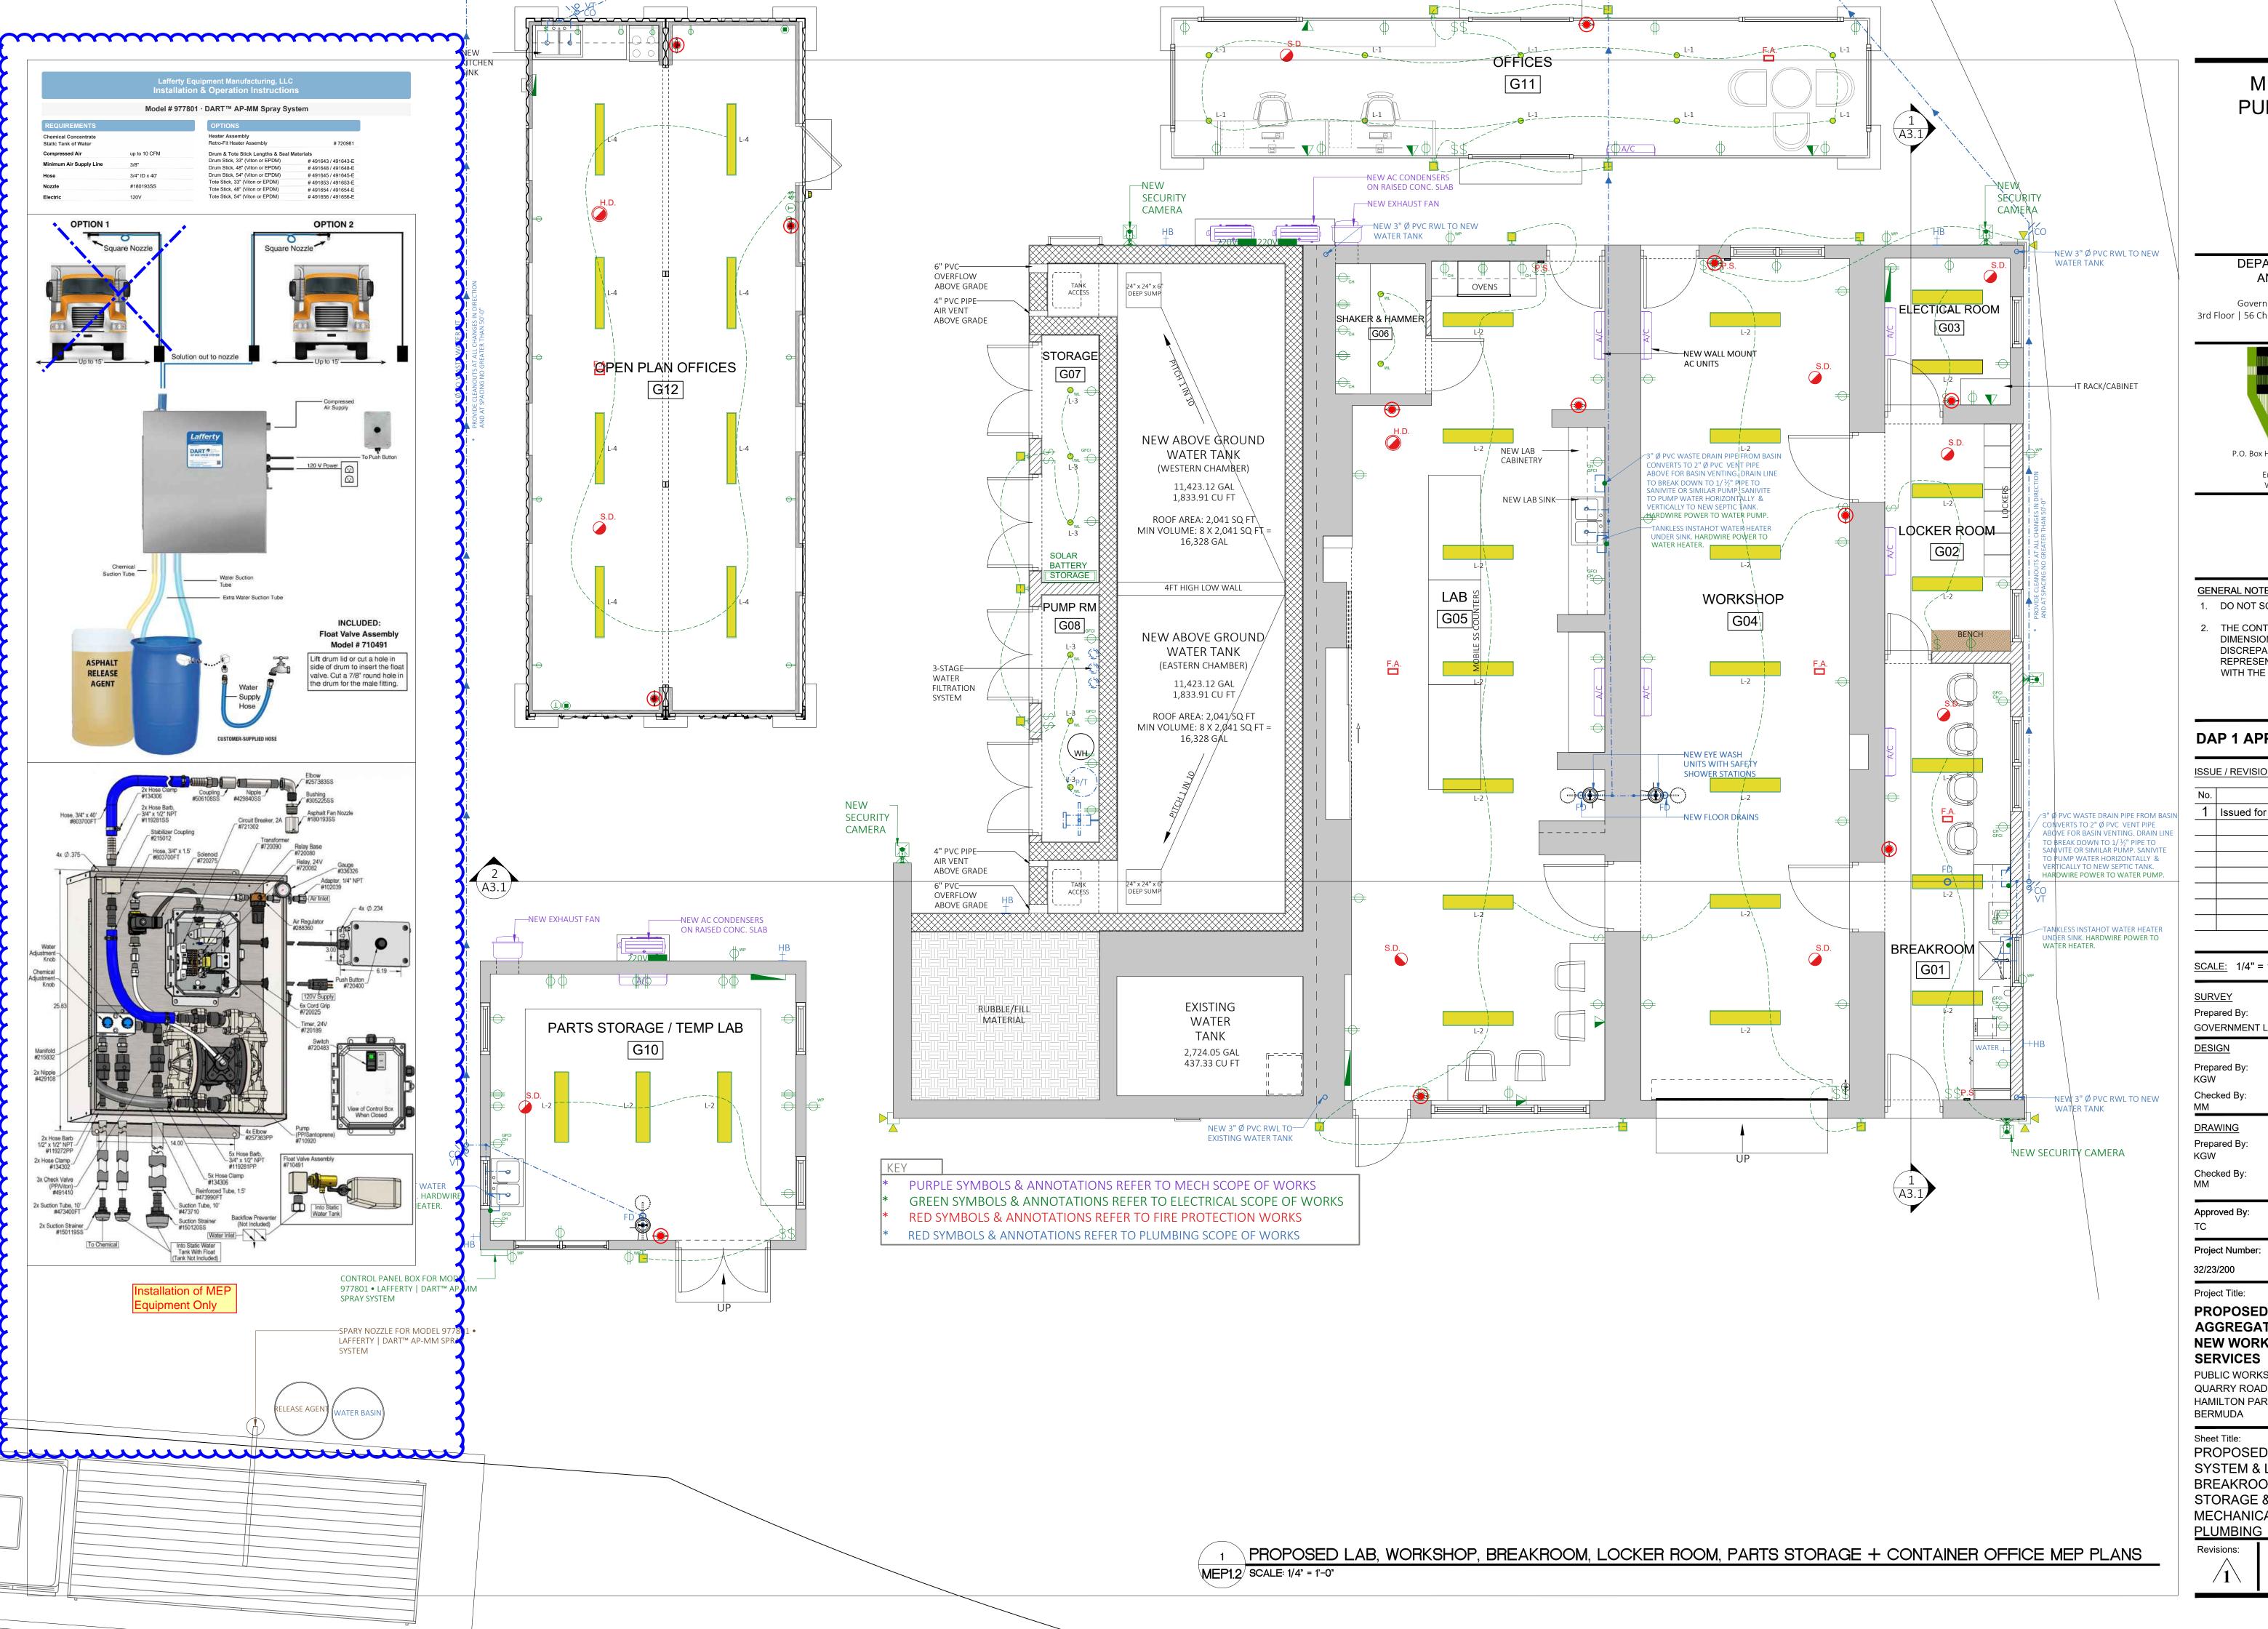

MINISTRY OF **PUBLIC WORKS** 




#### DEPARTMENT OF WORKS AND ENGINEERING

Government Administration Building, 3rd Floor | 56 Church Street | Hamilton, Bermuda HM12 Tel: (441) 501-3005



P.O. Box HM 428, Hamilton, Bermuda HM BX Tel: +1 441 707 0700 Email: info@brickverde.com

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### **GENERAL NOTES**
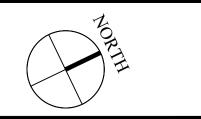
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2. THE CONTRACTOR SHALL VERIFY ALL DIMENSIONS ON SITE AND REPORT ANY DISCREPANCIES TO THE OWNERS REPRESENTATIVE BEFORE PROCEEDING WITH THE WORKS.

## DAP 1 APPLICATION DRAWINGS

ISSU	E / REVISION	
No.		Date:
1	Issued for Tender	19 Aug 2024

SCALE: 1/4" = 1'-0"	
SURVEY	
Prepared By:	Date:
GOVERNMENT LAND SURVEY DEPT	
DESIGN	
Prepared By: KGW	Date: 15/05/2024

Checked By: Date: 15/05/2024 DRAWING Prepared By: Date: KGW 15/05/2024 Checked By: 15/05/2024

## Approved By:

Project Number:	Brick Verde Ref Numbe
32/23/200	240219A

Project Title:

PROPOSED ASPHALT PLANT, AGGREGATE SCREENING PLANT, NEW WORKSHOP, LAB AND SITE **SERVICES** 

PUBLIC WORKS QUARRY & DEPOT QUARRY ROAD HAMILTON PARISH

Sheet Title:

PROPOSED RELEASE AGENT SPRAY SYSTEM & LAB, WORKSHOP, BREAKROOM, LOCKER ROOM, PARTS STORAGE & CONTAINER OFFICE MECHANICAL, ELECTRICAL,

Revisions:

Sheet Number: **MEP1.2**