

Ministry of Public Works

Department of Works and Engineering

Request for Proposals

For

Asphalt Plant Site Works

ADDENDUM 1

Request for Proposals No.: PN/2024-002-Q-AP

Issued: Friday July 26, 2024

Submission Deadline: Friday September 6, 2024 03:00:00 PM Bermuda Local Time

RFP (Consecutive Negotiations) – Asphalt Plant Site Works

Page 1 of 2

Asphalt Plant Site Works - ADDENDA #1

ADDENDUM 1

1. The following RFP Timetable has been revised per the request of the potential bidders.

Key Dates

Issue Date of RFP	Friday July 26, 2024
Pre-Bid / Site Meeting	Tuesday August 13, 2024 11:00 AM
Deadline for Questions	Friday August 30, 2024
Deadline for Issuing Addenda	Wednesday September 4, 2024
Submission Deadline	Friday September 6, 2024 03:00:00 PM
Rectification Period	5 business days
Anticipated Ranking of Proponents	Friday September 20, 2024
Contract Negotiation Period	30 calendar days
Anticipated Execution of Agreement	Friday October 11, 2024

All times listed are Bermuda local time. The RFP timetable is tentative only and may be changed by the Government at any time. For greater clarity, business days means all days that the Government is open for business.

- 2. Scope of Work The Owner shall not supply any materials shown on the drawings, i.e. reinforcing steel, anchor bolts, embeds, etc. required by the Proponent to complete the Works as detailed on the drawings.
- 3. Please refer to the attached 26 drawings for changes and extra details of the Works.
- 4. Please note that the design continues to be defined and another addenda should be expected.

A1 - 002

Asphalt Plant Site Works - ADDENDA #1

1.0 <u>GENERAL</u>	3.0 REINFORCING ST
1.1 THESE NOTES APPLY TO ALL STRUCTURAL DRAWINGS AND ARE TO BE READ IN CONJUNCTION WITH THE CONTRACT DOCUMENTS AND SPECIFICATIONS.	3.1 REINFORCING ST STRENGTH OF 40
1.2 DO NOT SCALE THE DRAWINGS. DIMENSIONS ARE TO BE USED AS A GUIDE ONLY.	3.2 REINFORCING ST ASTM A767.
1.3 ALL DETAILS AND ARRANGEMENTS OF EXISTING CONDITIONS, DIMENSIONS, ETC. TO BE FIELD VERIFIED PRIOR TO CONSTRUCTION. ANY DISCREPANCIES SHALL BE BROUGHT TO THE ENGINEER'S ATTENTION.	3.3 REBAR AT ENDS STAIRS, PAD FOO BENDS WITH TH WHICH IS CUT A
1.4 CONTRACTOR TO MAKE GOOD ANY DAMAGES CAUSED ON SITE, REPAIRING TO MATCH EXISTING OR AS APPROVED BY THE OWNER.	ZINC RICH PAINT APPROVAL OF TI
1.5 THE CONTRACTOR SHALL SUPPLY ALL NECESSARY MATERIALS, EQUIPMENT AND LABOR TO COMPLETE THE WORK, UNLESS OTHERWISE INDICATED.	3.4 MINIMUM LAP I T25 - 1500 (60")
1.6 THE CONTRACTOR SHALL PROVIDE COMPETENT SUPERVISORY STAFF AT ALL TIMES DURING THE WORK. TRADESMEN ARE TO BE SKILLED AND QUALIFIED FOR THE TASKS ASSIGNED.CONTRACTOR SHALL SUPPLY ALL NECESSARY MATERIALS, EQUIPMENT AND LABOR TO COMPLETE THE WORK, UNLESS OTHERWISE INDICATED.	T20 - 1000 (40") T16 - 800 (32") T12 - 600 (24") T10 - 500 (20")
1.7 THE CONTRACTOR SHALL PROVIDE ALL SAFETY EQUIPMENT AND GEAR TO CONFORM TO THE NATIONAL HEALTH AND SAFETY REGULATIONS APPLICABLE TO BERMUDA.	3.5 MINIMUM ANCH T20 - 850 (34") T16 - 700 (28") T12 - 550 (22") T10 - 300 (12")
1.8 THE CONTRACTOR SHALL VERIFY ALL SITE CONDITIONS AND FAMILIARIZE THEMSELVES WITH THE SCOPE OF WORK.	4.0 MASONRY
1.9 ALL CONSTRUCTION OPERATIONS ARE TO COMPLY WITH THE MINIMUM	4.1 WALLS TO BE CO
REQUIREMENTS OF THE BERMUDA RESIDENTIAL BUILDING CODE 2014.	4.2 FOR BED AND HE THE PROJECT DR EXCEPT THAT TH PLACED OVER FO
2.1 STRUCTURAL CONCRETE STRENGTH TO BE A MINIMUM OF 30 MPa (4350 PSI).	MORE THAN $\frac{3}{4}$ " (1
2.2 CONCRETE BLINDING/LEAN MIX BUILD UP STRENGTH MUST BE A MINIMUM OF 14MPa (2000 PSI).	4.3 IN EACH WYTHE SUCCESSIVE COU THE UNIT LENGT
2.3 REINFORCING CHAIRS TO BE PLASTIC, OR CONCRETE.	4.4 FOR MASONRY L
2.4 NO ADDITIVES TO BE USED WITHOUT THE PRIOR APPROVAL OF THE ENGINEER. NO WATER SHALL BE ADDED TO THE MIX ON SITE WITHOUT THE PRIOR APPROVAL OF THE ENGINEER.	PLASTIC AND UN EXTRUDE MORTA DEEP FURROWIN ANY UNITS DISTU
2.5 THE CONTRACTOR SHALL GIVE A MINIMUM OF 48 HOURS NOTICE TO THE ENGINEER PRIOR TO POURING ANY CONCRETE.	AFTER INITIAL PL FRESH MORTAR. SHALL BE CLEAN
2.6 CONCRETE COVER TO BE 3" FOR CONCRETE CAST AGAINST AND PERMANENTLY EXPOSED TO EARTH (E.G. RETAINING WALLS AND FOUNDATIONS), 2" FOR CONCRETE EXPOSED TO WEATHER AND 1.5" FOR CONCRETE NOT EXPOSED TO WEATHER OR EARTH U.N.O	4.5 MASONRY UNITS MINIMUM AVER BASED ON THE N
2.7 CONCRETE IS TO CURE FOR 7 DAYS MINIMUM PRIOR TO LOADING U.N.O.	4.6 MORTAR SHALL SHALL BE OF GRA
2.8 EXPERIENCED PERSONNEL SHALL MECHANICALLY VIBRATE ALL STRUCTURAL CONCRETE IN THE APPROVED MANNER. THE CONTRACTOR SHALL HAVE AT LEAST TWO FULLY OPERATIONAL POKER VIBRATORS ON SITE DURING CONCRETE PLACEMENT.	4.7 ALL CELLS TO BE ALL CELLS CONTA CELLS BELOW BE SHALL BE REINFC
2.9 ALL FORMWORK, SHORING AND RESHORING SHALL BE DESIGNED BY THE CONTRACTOR'S REGISTERED ENGINEER.	A MINIMUM OF 2 FULL HEIGHT U.N
2.10 FOUNDATIONS, WALLS, SLABS, BEAMS AND GIRDERS SHALL NOT HAVE JOINTS IN A HORIZONTAL PLANE UNLESS SHOWN OTHERWISE.	4.8 FILLED BLOCK W CONCRETE MUST ALLOW THE NEX
2.11 CONCRETE SLUMP TO BE AS FOLLOWS : BEAMS/FOOTINGS/COLUMNS AND SLABS = 5" +/- 1" MASONRY BLOCK FILL = 7" +/- 1"	4.9 WHERE NEW WA
2.12 CONCRETE BEAMS TO HAVE A MINIMUM BEARING OF 8" ON EACH SIDE ONTO SOLID CONCRETE OR FILLED MASONRY BLOCK (WALL STIFFENER/WS) WITH A MINIMUM WIDTH OF THE RESPECTIVE BEAM U.N.O.	4.10 CONCRETE BON WALLS W/ MIN W/ 2 T12 MID H
	4.11 ALL CORNERS T CELLS IN ALL DI

TEEL SHALL HAVE A MINIMUM 400 MPa (OR APPROVED EQUAL).

TEEL TO BE GALVANISED IN ACCORDANCE CLASS II STANDARD

S OF CONCRETE LINTELS, WALL STIFFENERS, COLUMNS, OTINGS, BEAMS AND SLABS ARE TO HAVE STANDARD 90° HE MINIMUM ANCHORAGE/LAP LENGTHS U.N.O. ANY REBAR AND BENT ON SITE SHALL HAVE TWO APPLICATIONS OF A APPLIED TO THE ENDS AND DAMAGED AREAS TO THE HE ENGINEER.

LENGTHS UNO:

HORAGE LENGTHS UNO:

ONSTRUCTED OF RUNNING BOND MASONRY.

EAD JOINTS : UNLESS OTHERWISE REQUIRED OR INDICATED ON RAWINGS, HEAD AND BED JOINTS SHALL BE 🖁 (10mm) THICK, IE THICKNESS OF THE BED JOINT OF THE STARTING COURSE OUNDATIONS SHALL NOT BE LESS THAN $\frac{1}{4}$ " (7mm) AND NOT 19mm)

E OF MASONRY LAID IN RUNNING BOND, HEAD JOINTS IN JRSES SHALL BE OFFSET BY NOT LESS THAN ONE-FOURTH

UNIT PLACEMENT, THE MORTAR SHALL BE SUFFICIENTLY IITS SHALL BE PLACED WITH SUFFICIENT PRESSURE TO FAR FROM THE JOINT AND PRODUCE A TIGHT JOINT. NG OF BED JOINTS THAT PRODUCES VOIDS IS NOT PERMITTED. URBED TO THE EXTENT THAT THE INITIAL BOND IS BROKEN LACEMENT SHALL BE REMOVED AND RE-LAID IN . SURFACES TO BE IN CONTACT WITH MORTAR I AND FREE OF DELETERIOUS MATERIALS.

IS SHALL CONFORM TO THE LATEST VERSION OF ASTM C90 (THE RAGE COMPRESSIVE STRENGTH OF 3 UNITS SHALL BE 2000 PSI NET AREA OF THE UNITS.

CONFORM TO THE LATEST VERSION OF ASTM C-270 AND ADE S OR GREATER.

E FILLED ARE TO BE KEPT CLEAR OF OBSTRUCTIONS. AINING VERTICAL REINFORCING SHALL BE FILLED. EARING BEAMS/LINTELS SHALL BE SOLID FILLED AND DRCED WITH MIN 1-T12 BAR. REBAR TO ANCHOR A 2' INTO THE FOOTING. CELLS ARE TO BE SOLID FILLED TO I.O.

ORK MUST BE POURED IN MAXIMUM OF 4' HIGH LIFTS. F BE STOPPED 2" FROM THE TOP OF THE BLOCK TO (T LIFT TO KEY TOGETHER.

ALLS BUTT UP AGAINST EXISTING WALLS, A 4" KEY INTO THE IS REQUIRED EVERY 2ND COURSE OF BLOCK.

ND BEAMS SHALL BE PROVIDED ON THE TOP OF ALL NEW NIMUM OF 8" DEEP AND THE SAME WIDTH AS WALL HEIGHT CONTINUOUS THROUGHOUT THE BOND BEAM.

TO BE FILLED WITH MIN 2000 PSI CONCRETE, 3 DIRECTIONS.

5.0 FOUNDATIONS

- **5.1 ALL FOOTINGS AND FOUNDATIONS TO BEAR** ROCK. BEARING MATERIAL IS TO REMAIN UN BY THE ENGINEER PRIOR TO PLACING THE CC
- **5.2 ALL SHORING, SHEETING AND DEWATERING** OF THE CONTRACTOR
- 5.3 THE CONTRACTOR SHALL TAKE PRECAUTIONS AND SURROUNDING INFRASTRUCTURE
- **5.4 UNDERSIDE OF SCREENING PLANT FOUNDAT** CONCRETE BLINDING/LEAN MIX AS REQUIRE CONCRETE FOOTING ELEVATION.
- 5.5 BACKFILL MATERIAL SHALL BE FREE FROM O DEBRIS AND LARGE ROCKS. BACKFILL SHALL I IN LAYERS NOT EXCEEDING 6". THE BACKFILL COMPACTED TO A MINIMUM OF 95% COMP

6.0 INSPECTION AND TESTING

6.1 CONTRACTOR TO PROVIDE 48 HOURS NOTIC FOR THE INSPECTION OF ALL REINFORCEMEN MASONRY REINFORCEMENT PRIOR TO POUR BE COVERED UP UNTIL SUCH TIME AS THE ON HAS APPROVED THE WORK.


7.0 DEMOLITION/EXCAVATIONS

- 7.1 WHERE NECESSARY, THE CONTRACTOR SHAL **PROVIDE INTERIOR AND EXTERIOR SHORING** PREVENT MOVEMENT, SETTLEMENT, OR COL OR ELEMENT TO BE DEMOLISHED, AND ADJA TO REMAIN.
- 7.2 IF UNEXPECTED MECHANICAL, ELECTRICAL O ARE ENCOUNTERED, THE CONTRACTOR SHAL TO THE ENGINEER.
- 7.3 THE CONTRACTOR SHALL LOCATE AND IDENT UTILITIES WITHIN THE SITE EXTENTS. IF UTILI CONTRACTOR SHALL ENSURE THAT THE UTIL PROTECTED THROUGHOUT THE WORKS.

8.0 CONNECTIONS

- 8.1 ALL NAILS, BOLTS, SCREWS, CLIPS, ANCHORS BE GALVANIZED OR STAINLESS STEEL.
- 8.2 IF GALVANIZED : ALL NUTS, BOLTS, WASHERS FASTENERS SHOULD BE HOT DIPPED GALVAN ASTM A153. ALL JOIST HANGERS. HURRICAN CONNECTIONS SHALL BE HOT DIPPED GALVA ASTM A525 TO A MINIMUM OF G60.
- 8.3 ANCHOR BOLTS SHALL BE SET IN THE CORREC TEMPLATES AND NOT FORCE FIT AFTER CON
- 8.4 NAILS AND NAILED CONNECTIONS SHALL CO FASTENING SCHEDULE IN THE BERMUDA RES
- 8.5 BOLT HOLES SHALL BE NO LARGER THAN $\frac{1}{16}$ " SHANK DIAMETER. ALL BOLTED JOINTS SHAL UNDER THE HEAD OF THE BOLT AND UNDER WASHERS FOR $\frac{1}{2}$ " BOLTS AND UNDER SHALL E DIAMETER X $\frac{1}{8}$ " THICK AND FOR $\frac{5}{8}$ " BOLTS A M DIAMETER AND $\frac{3}{16}$ " THICK.
- 8.6 BOLT STRENGTH TO BE A MINIMUM OF CLAS
- 8.7 ANCHOR ROD/BOLT/CONNECTION INSTALLA THE INSTRUCTIONS FOR USE (IFU) DOCUMEN THE PRODUCT.

		ENGIN	IEERING CONS	SULTANTS	:		_
	5		_				1
			Т		- 1		
ON UNDISTURBED SOUND	5	3					
NDISTURBED AND BE REVIEWED	2						•
INCRETE FOR FOUNDATIONS.	5					G SERVICE	S
SHALL BE THE RESPONSIBILITY	2	Pho	Serpentine Ro one: (441) 294 ail: info@iepc	1-3693	roke HM 0	7	
	\$		w.iepc.bm	DIII			
	2						
S TO PROTECT ALL EXISTING	5						
IONS TO BE RAISED WITH A LAYER OF	5						
D TO ACHIEVE THE SPECIFIED TOP OF							
•	5						
RGANIC MATTER, CONSTRUCTION							
BE WELL GRADED AND PLACED	5						
SHALL BE WATERED AND							
ACTION.	\$						
·	\$						
E TO THE ENGINEER OF RECORD	5						
IT, INCLUDING ING CONCRETE. NO WORK SHALL							
WNER'S REPRESENTATIVE	\$						
•	}						
	5						
L DESIGN AND	\$						
BRACING, OR SUPPORT TO							
LAPSE OF THE STRUCTURE	\$						
CENT FACILITIES OR WORK							
R STRUCTURAL ELEMENTS							
L SUBMIT DETAILS OF SUCH	2						
TIFY EXISTING UNDERGROUND	\$						
TIES ARE TO REMAIN, THE							
ITIES ARE SUPPORTED AND	\$						
AND HURRICANE TIES SHALL		REVI	SIONS				
•	\$	No.	DATE	BY		OR PRELIMINARY PRICING	
		00	2024-08-09	RGW	ISSUED F	-OR PRELIMINARY PRICING	
S, NAILS, SCREWS, AND OTHER IIZED IN ACCORDANCE WITH	\$						
E CLIPS AND OTHER							
NIZED IN ACCORDANCE WITH	5						
	2						
CT LOCATIONS USING	5	PROJ	ECT DETAII	LS			
CRETING.					JARRY	& DEPOT	
MPLY WITH APPENDIX B : NAIL	5		ARRY RO. Ailton f		-1		
IDENTIAL BUILDING CODE 2014.	2	BER	MUDA				
GREATER THAN THE BOLT	2						
L HAVE WASHERS FITTED	5	TITLE					
THE NUT. THE SIZE OF		STR	UCTURA	AL NO	ΓES		
BE A MINIMUM OF 2"	5						
INIMUM OF 2 $\frac{1}{2}$ "							
· · · · · · · · · · · · · · · · · · ·	5						
SS 4.6 OR EQUIVALENT.			GN BY: RG				
•	5	CHE	CKED BY: I	RB			
TIONS MUST FOLLOW							
ITATION PROVIDED WITH	5	JOBN	No:				
	}	DATE	: 09-4	AUG-20	24		
	X	Ĭ					
	5	REVIS	DIUN:	า		SHEET NO:	
			l l	J			

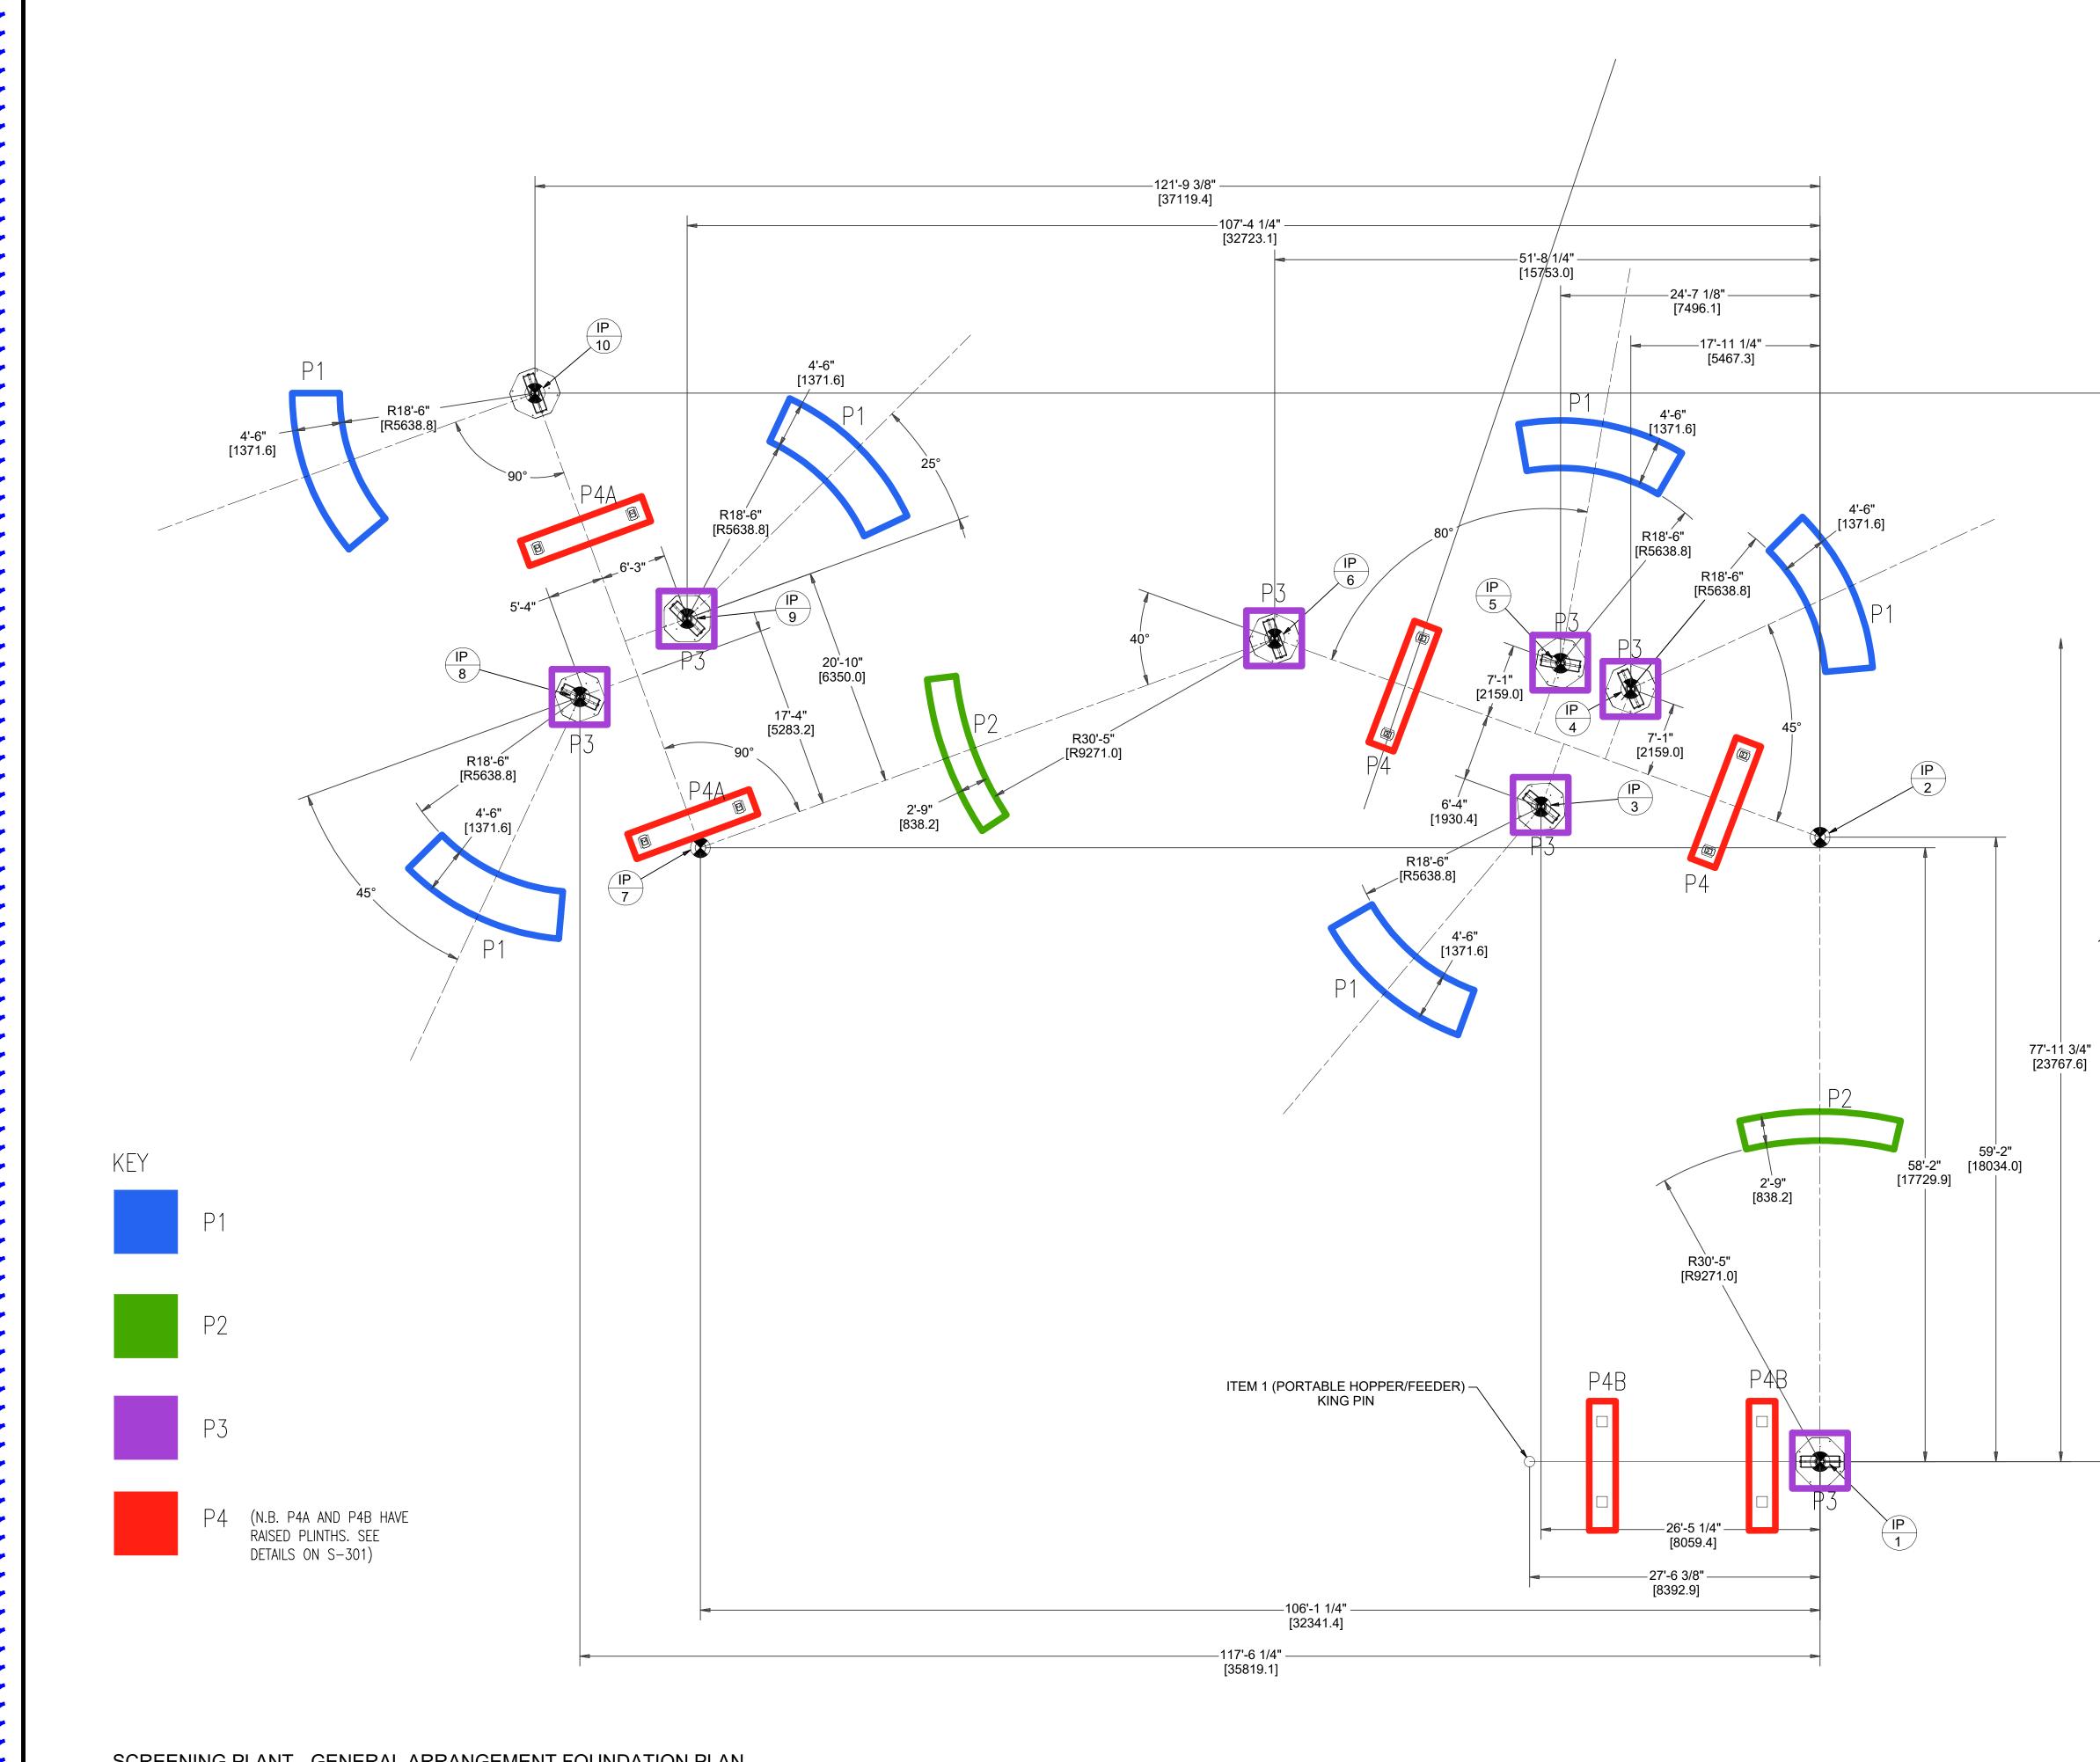

SCREENING PLANT - GENERAL ARRANGEMENT FOUNDATION PLAN NTS SCALE





ENGINEERING SERVICES 25 Serpentine Road, Pembroke HM 07 Phone: (441) 294-3693 Email: info@iepc.bm www.iepc.bm

PRELIMINARY

NOT TO BE USED FOR CONSTRUCTION

No.	DATE	BY	REVISION
NO.	DATE	Ы	REVISION
00	2023-08-09	RGW	ISSUED FOR PRELIMINARY PRICING
01	2024-08-12	RGW	ISSUED FOR PRELIMINARY PRICING

PROJECT DETAILS

101'-2 7/8" [30857.5]

PUBLIC WORKS QUARRY & DEPOT QUARRY ROAD HAMILTON PARISH BERMUDA

TITLE

SCREENING PLANT GENERAL ARRANGEMENT FOUNDATION PLAN

DESIGN BY: RGW

CHECKED BY: RB

JOB No: **#01230001**


DATE: 09-AUG-2024

REVISION:

0

S-100


SHEET No:

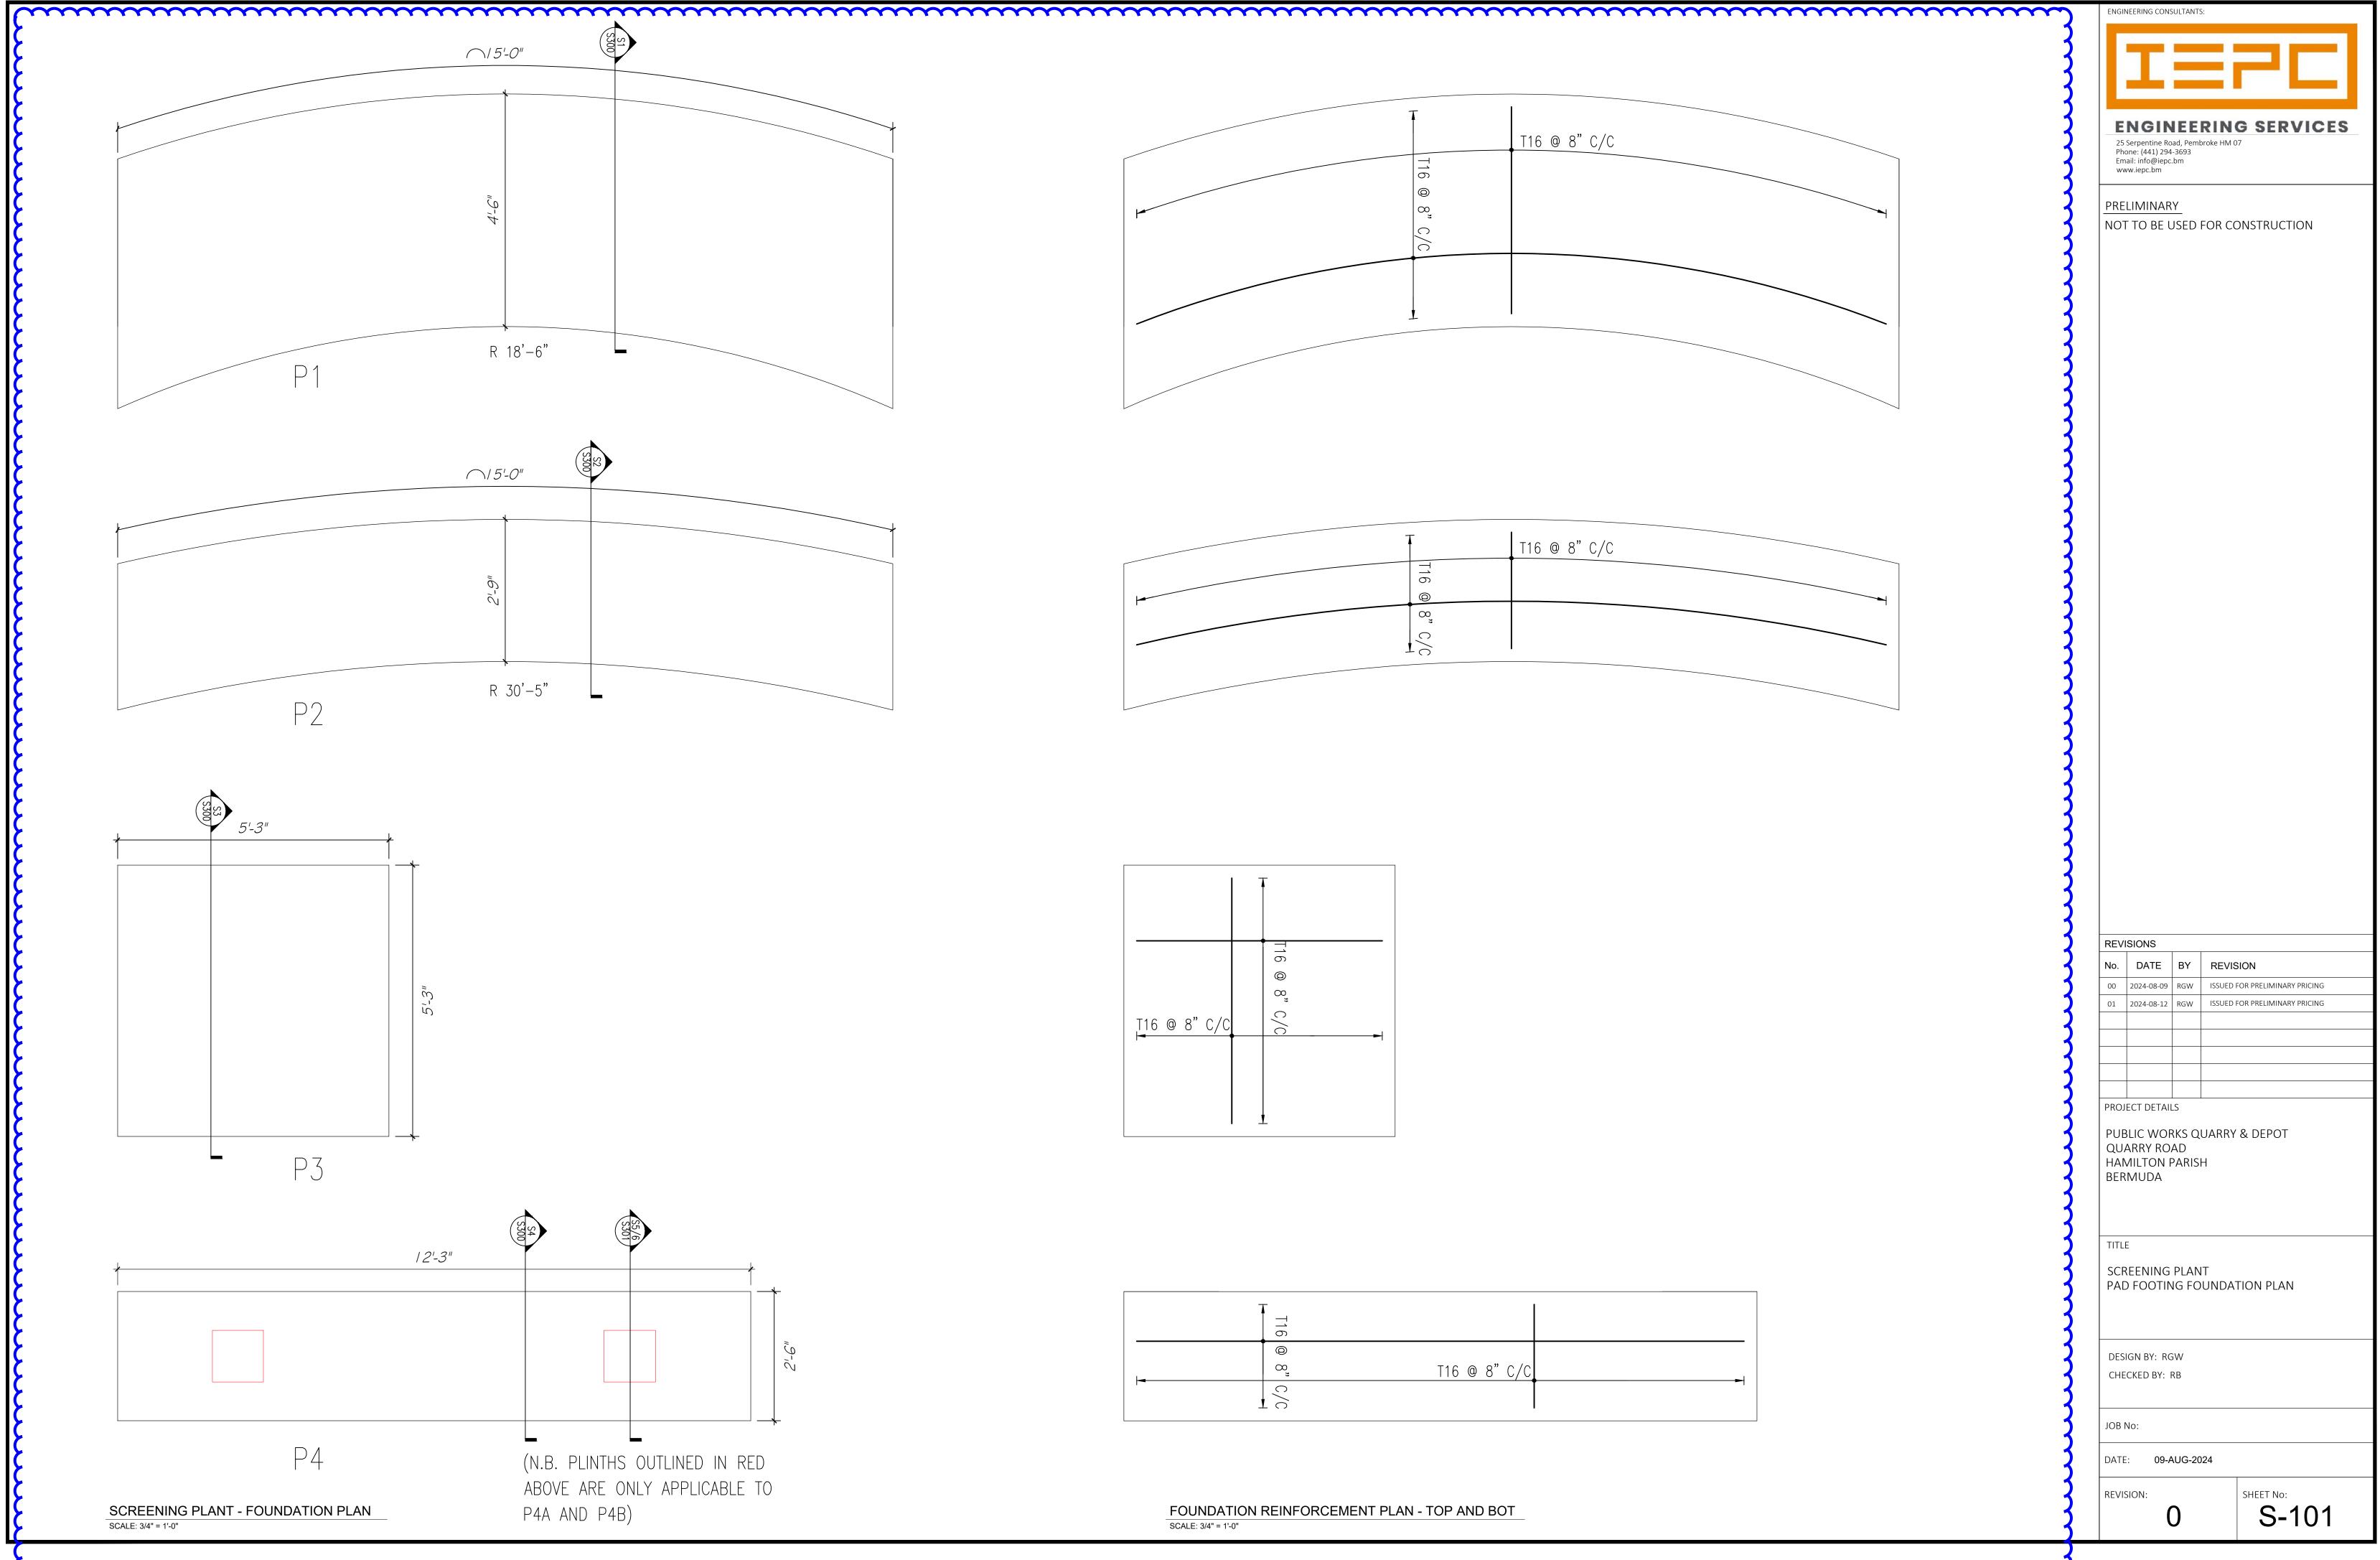



A MARKEN AND A MA


T16 @ 8" C/C	T12 @ 2" C/C	_ 1
-■		


-	Ŧ		1
	T16		
	Ø		
	l ∞ _j	T16 @ 8" C/C	
-			

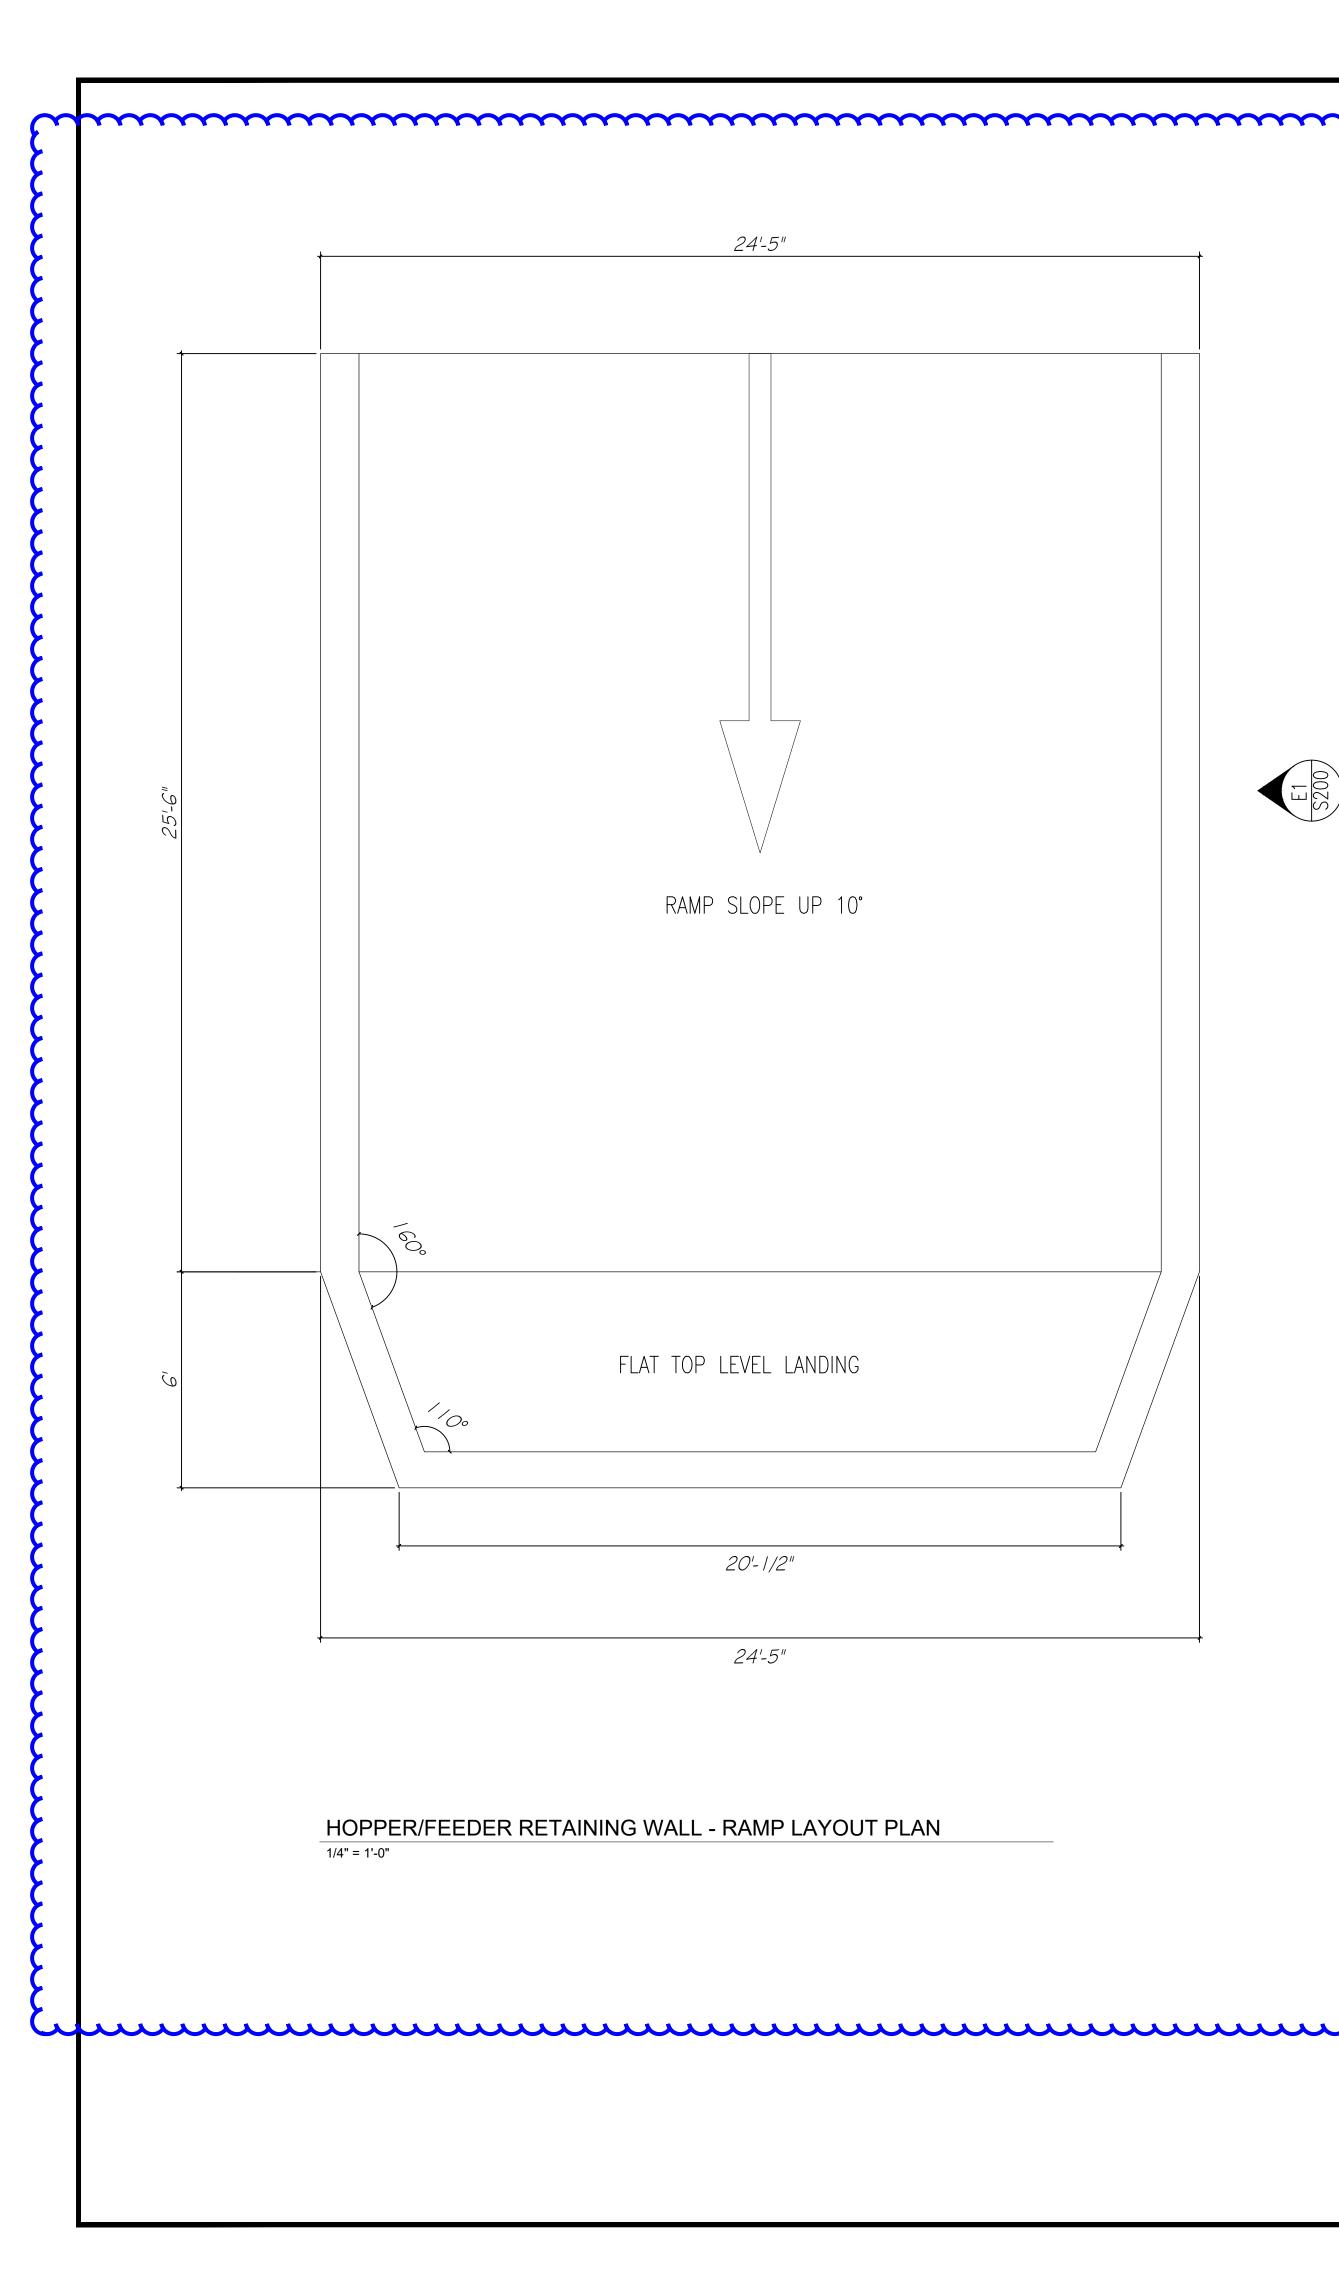


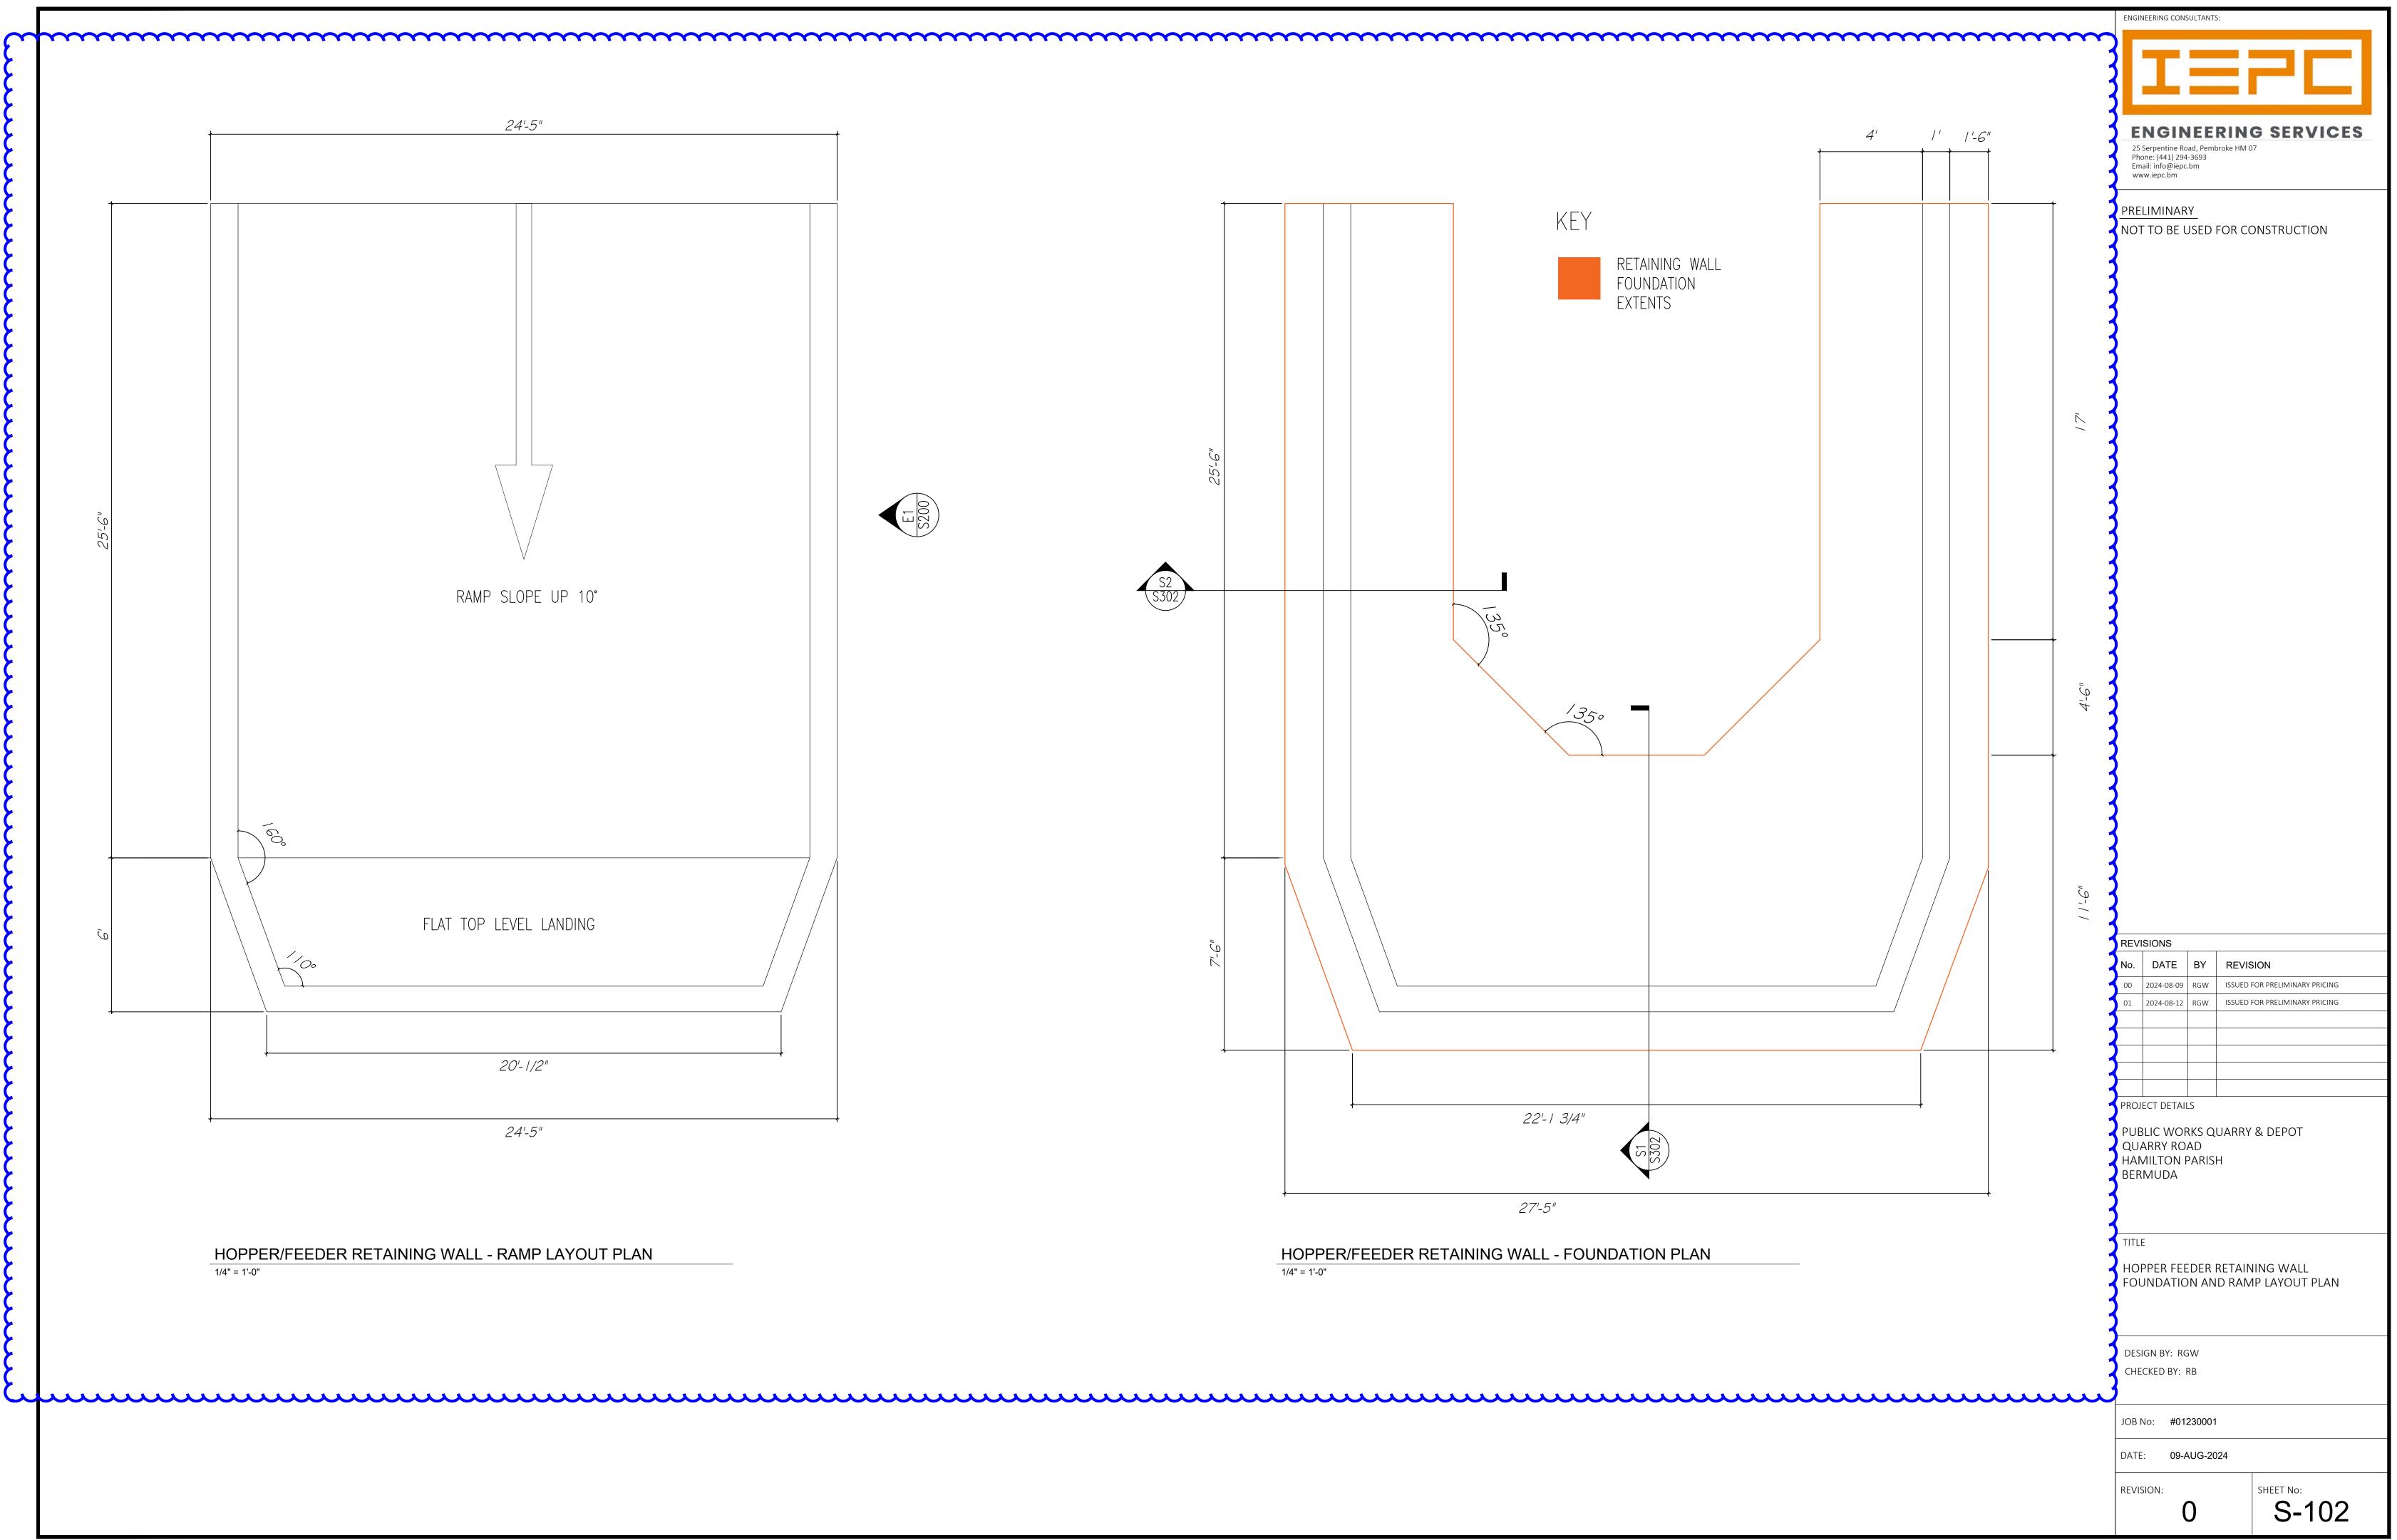


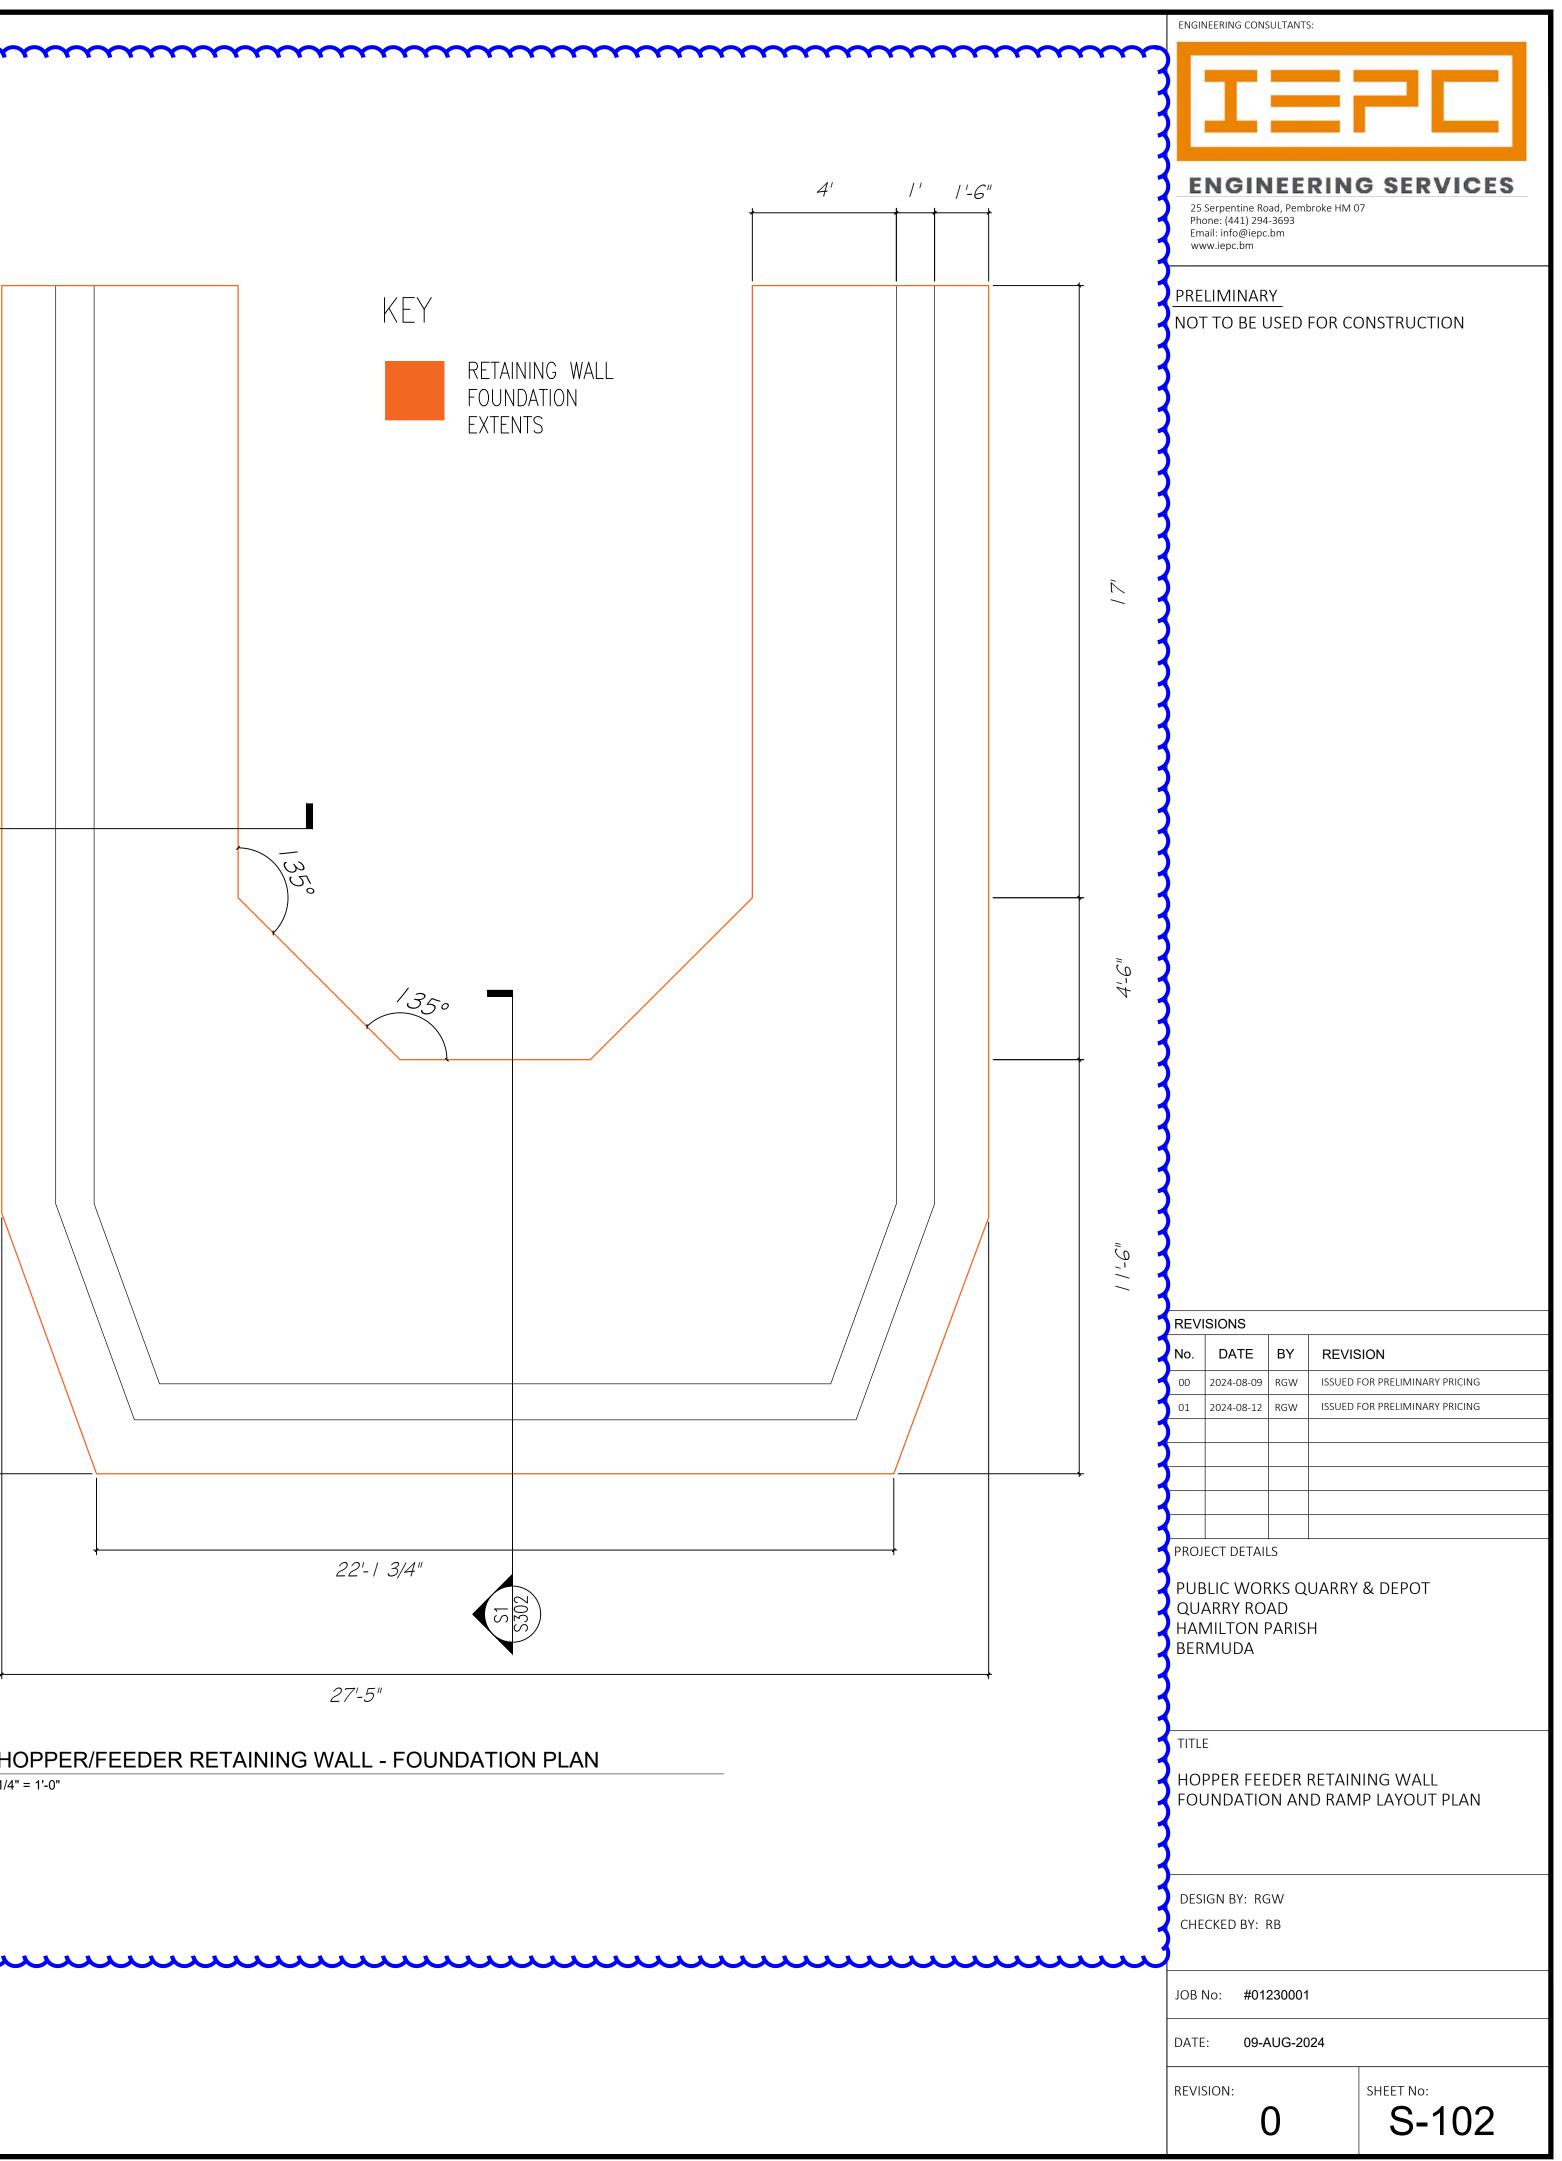


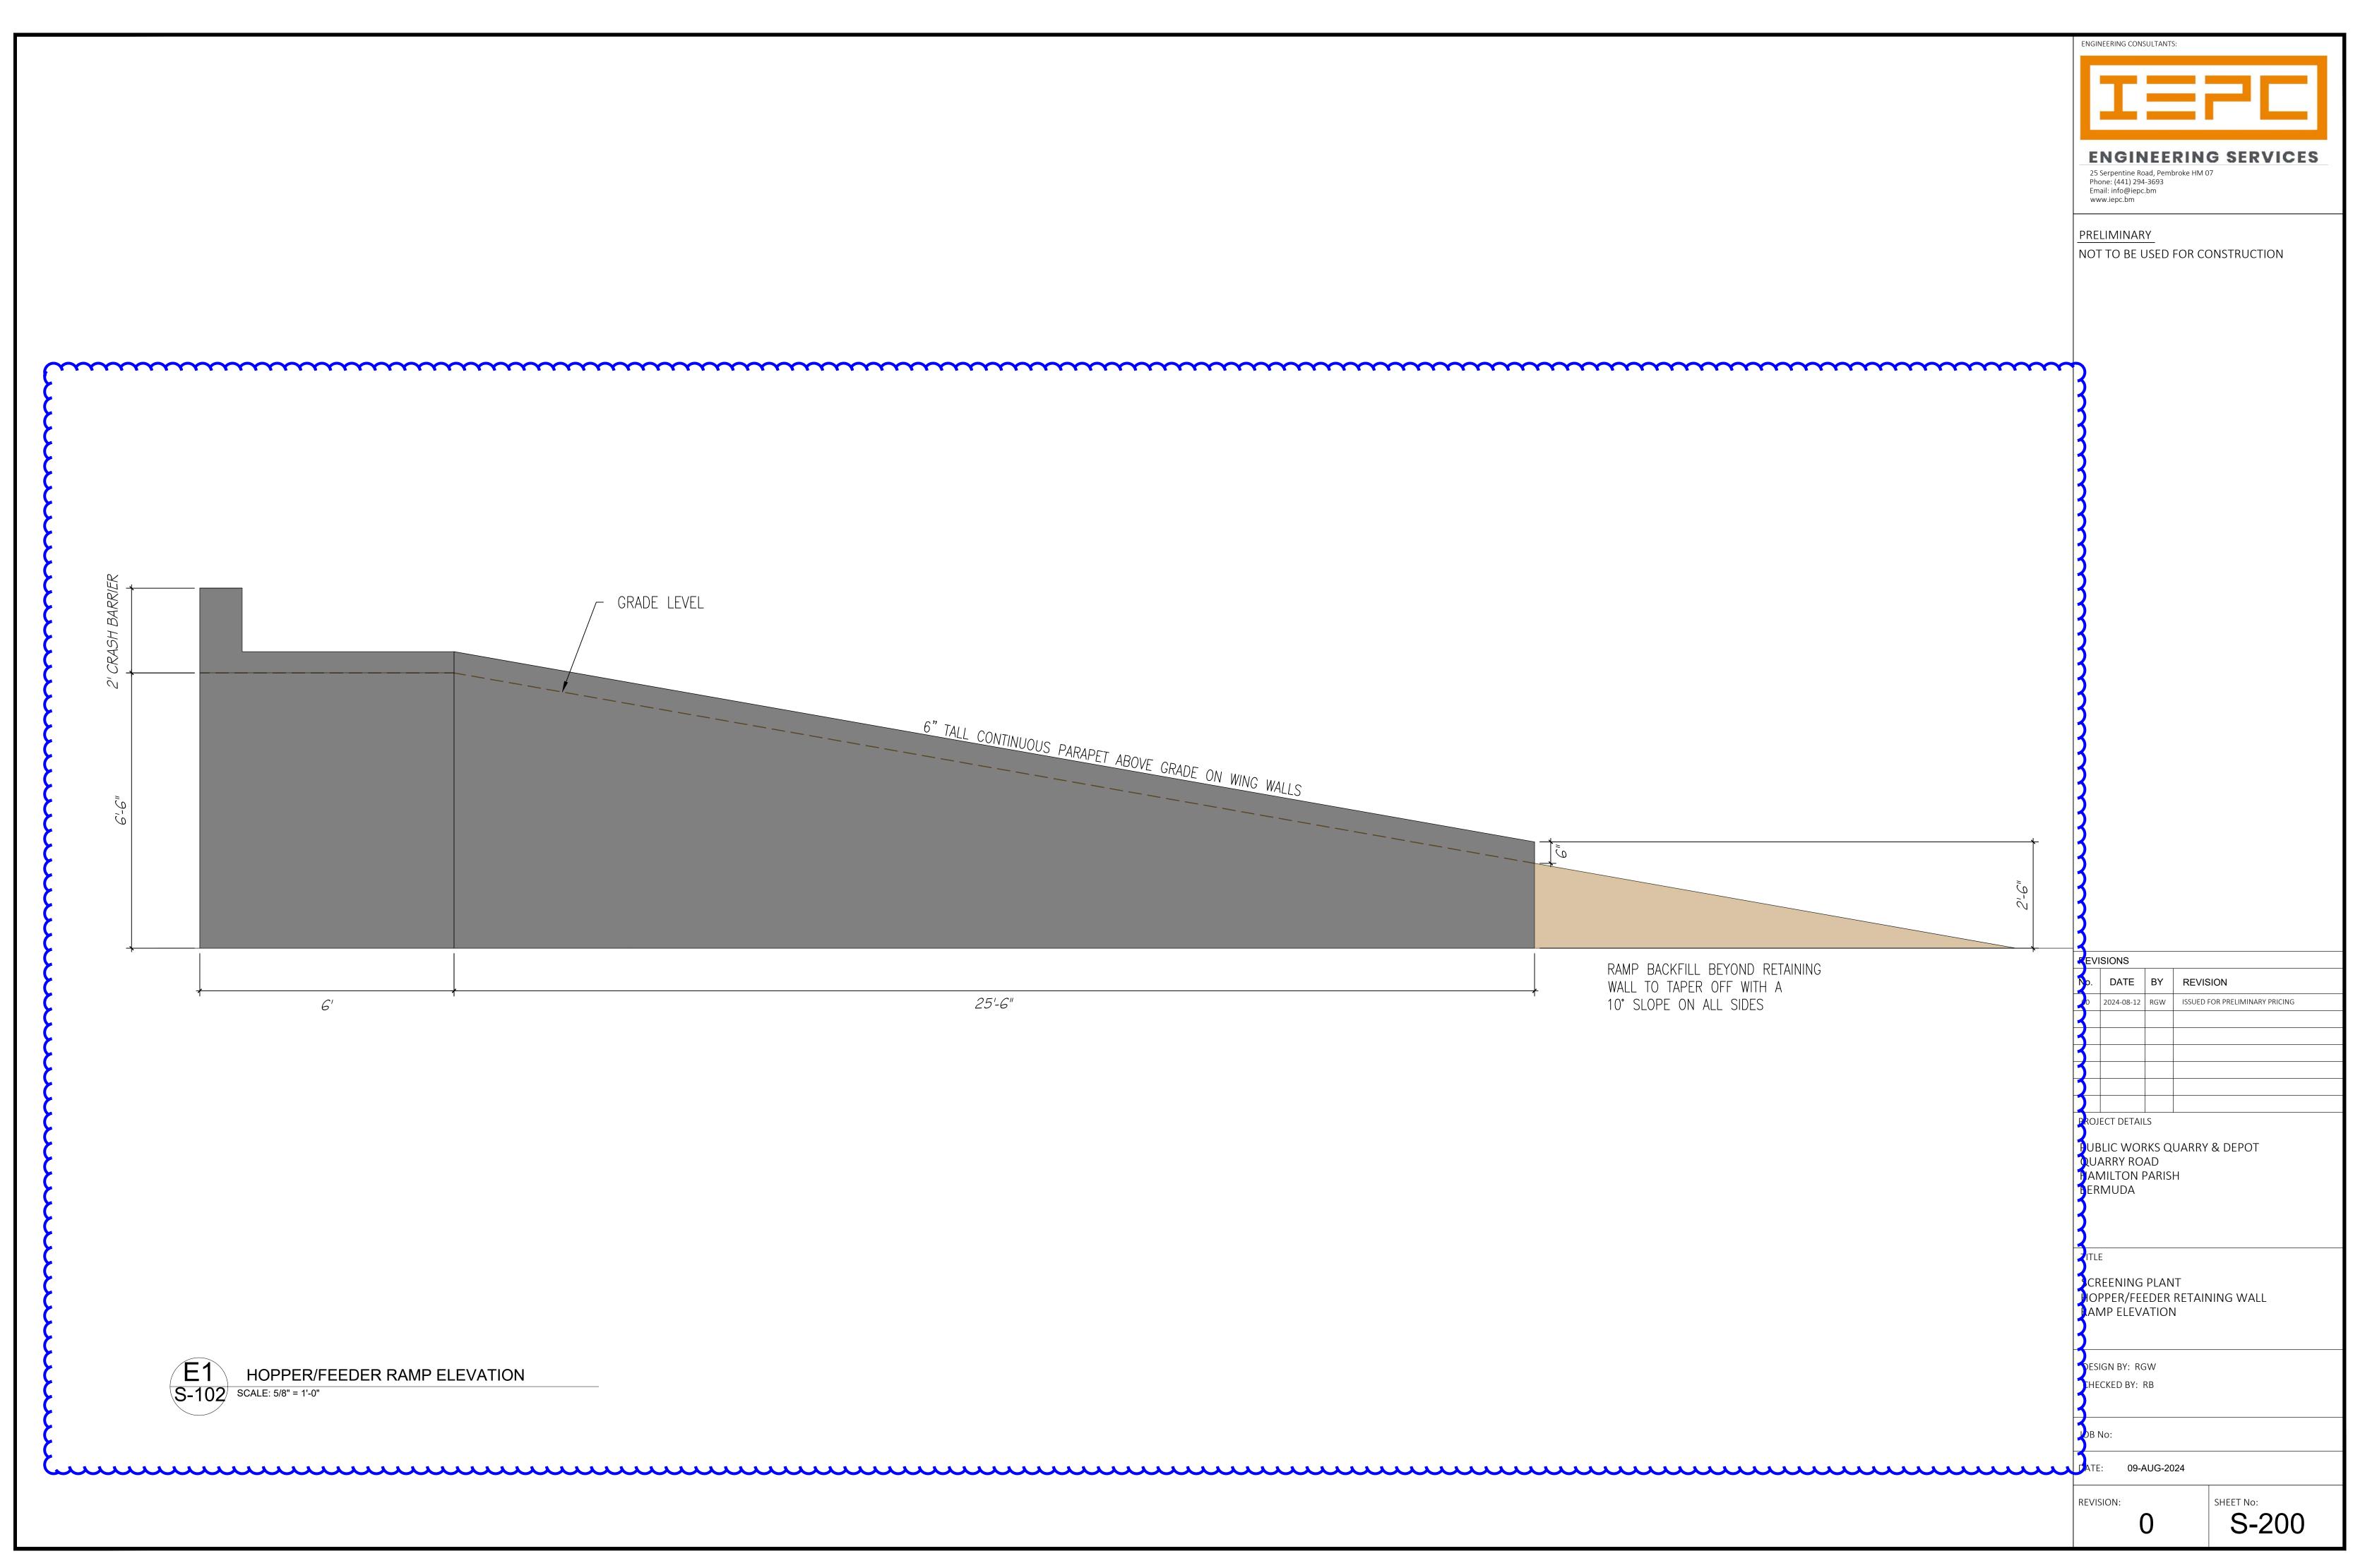

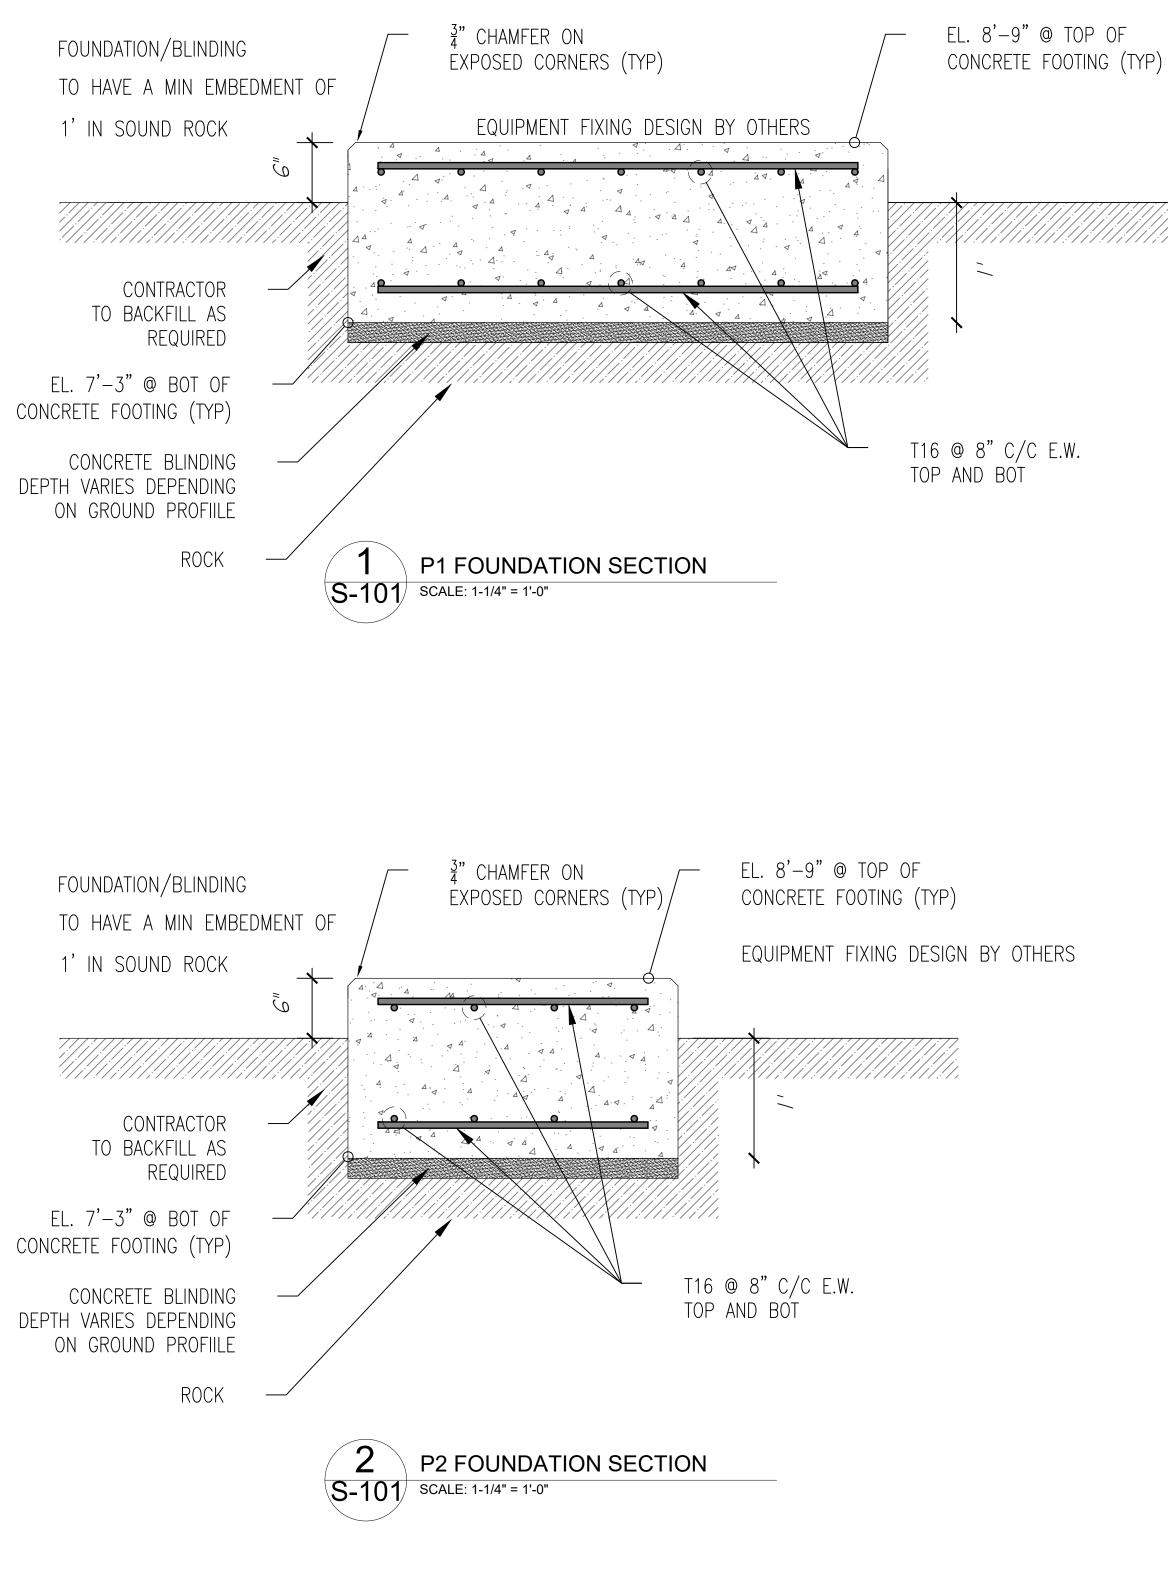

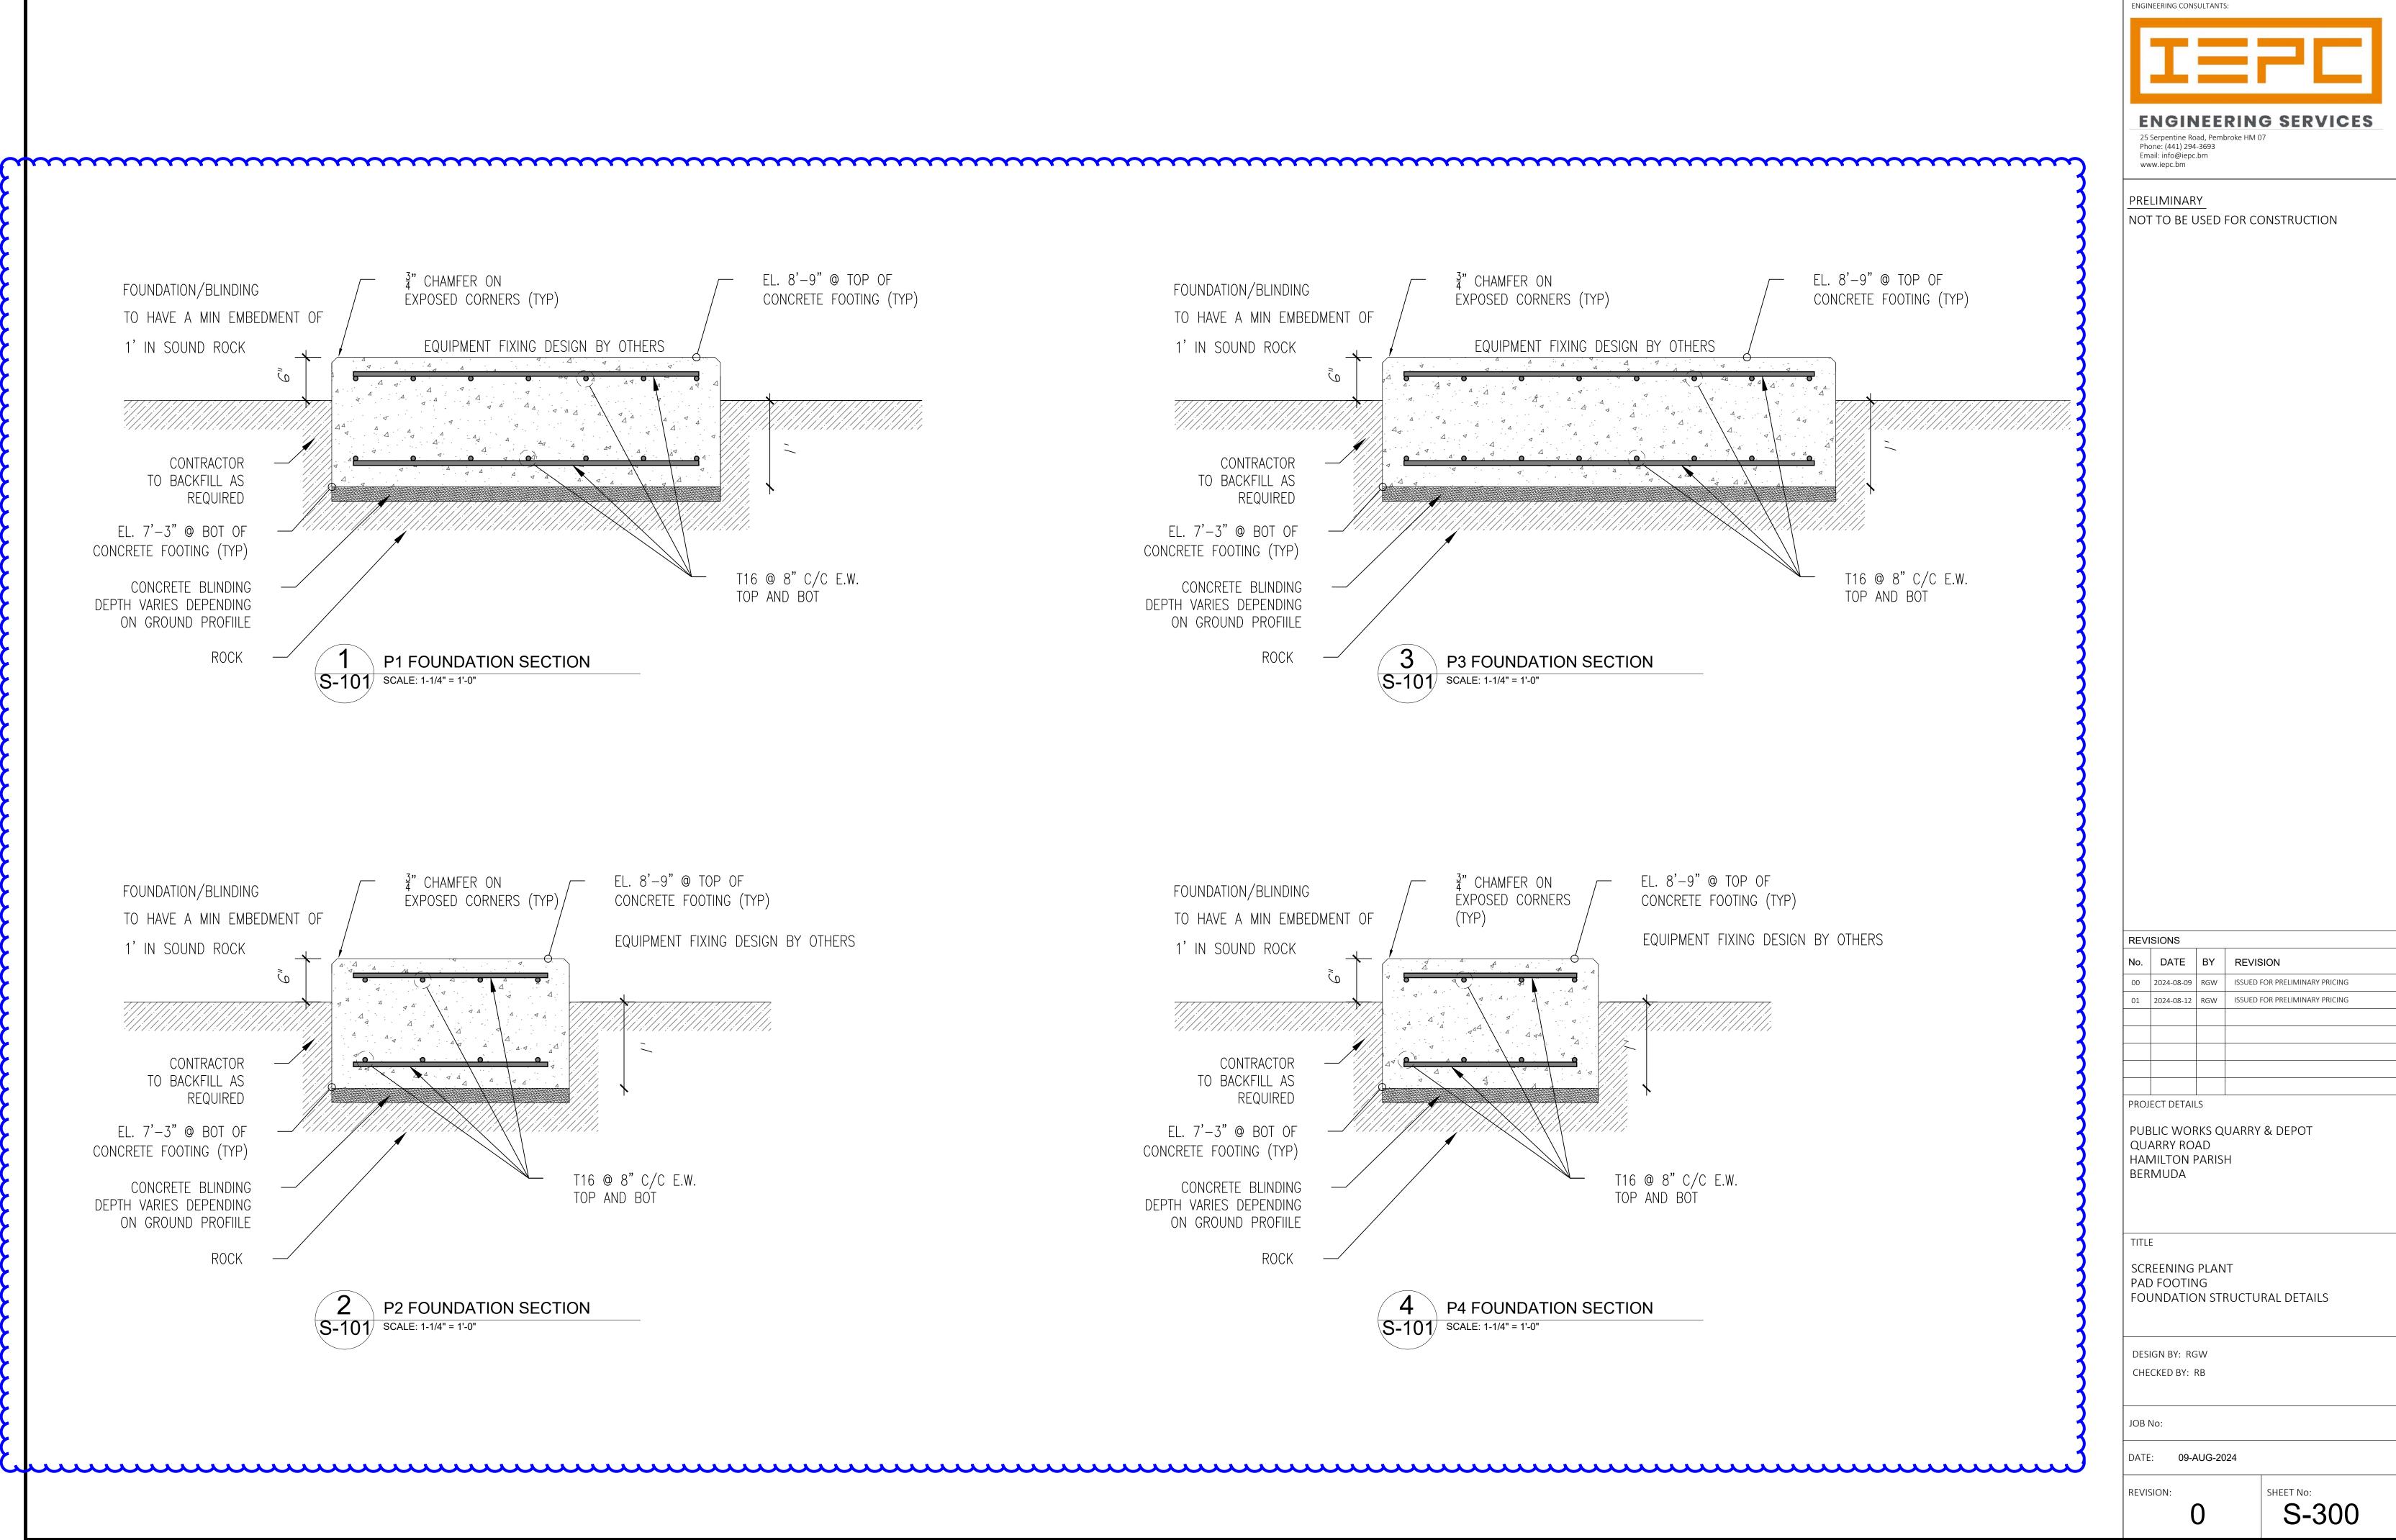

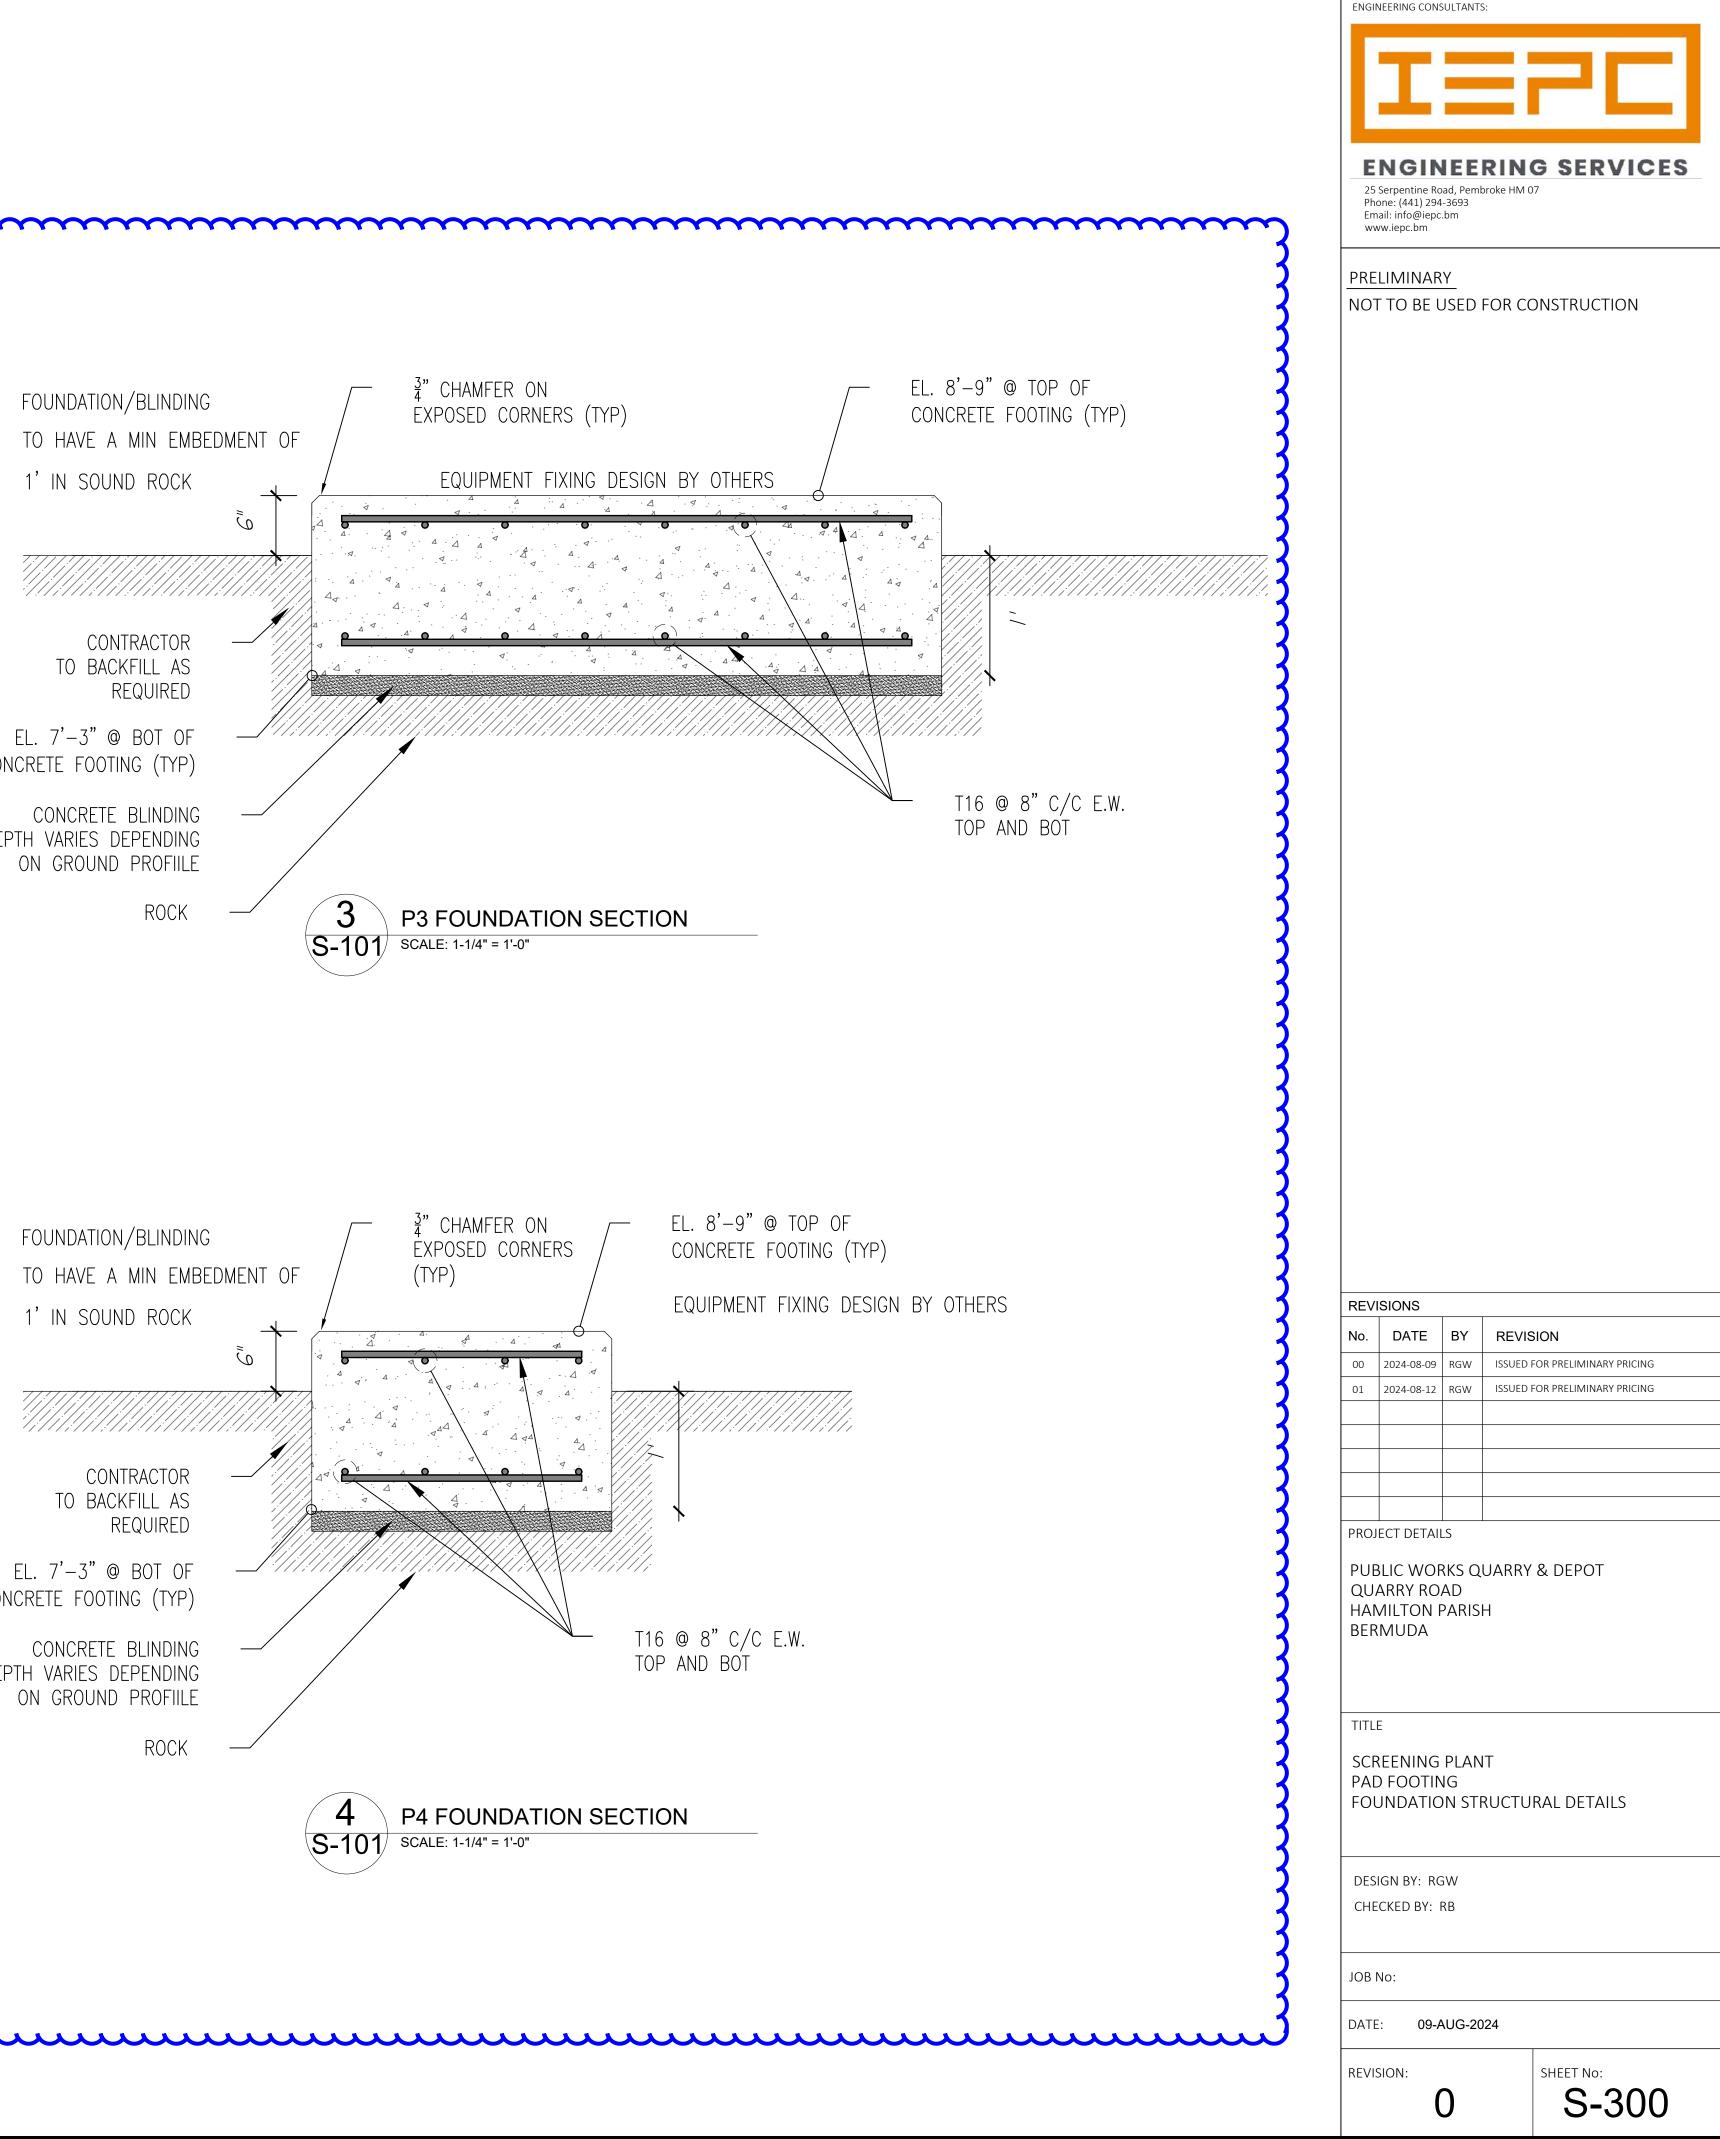

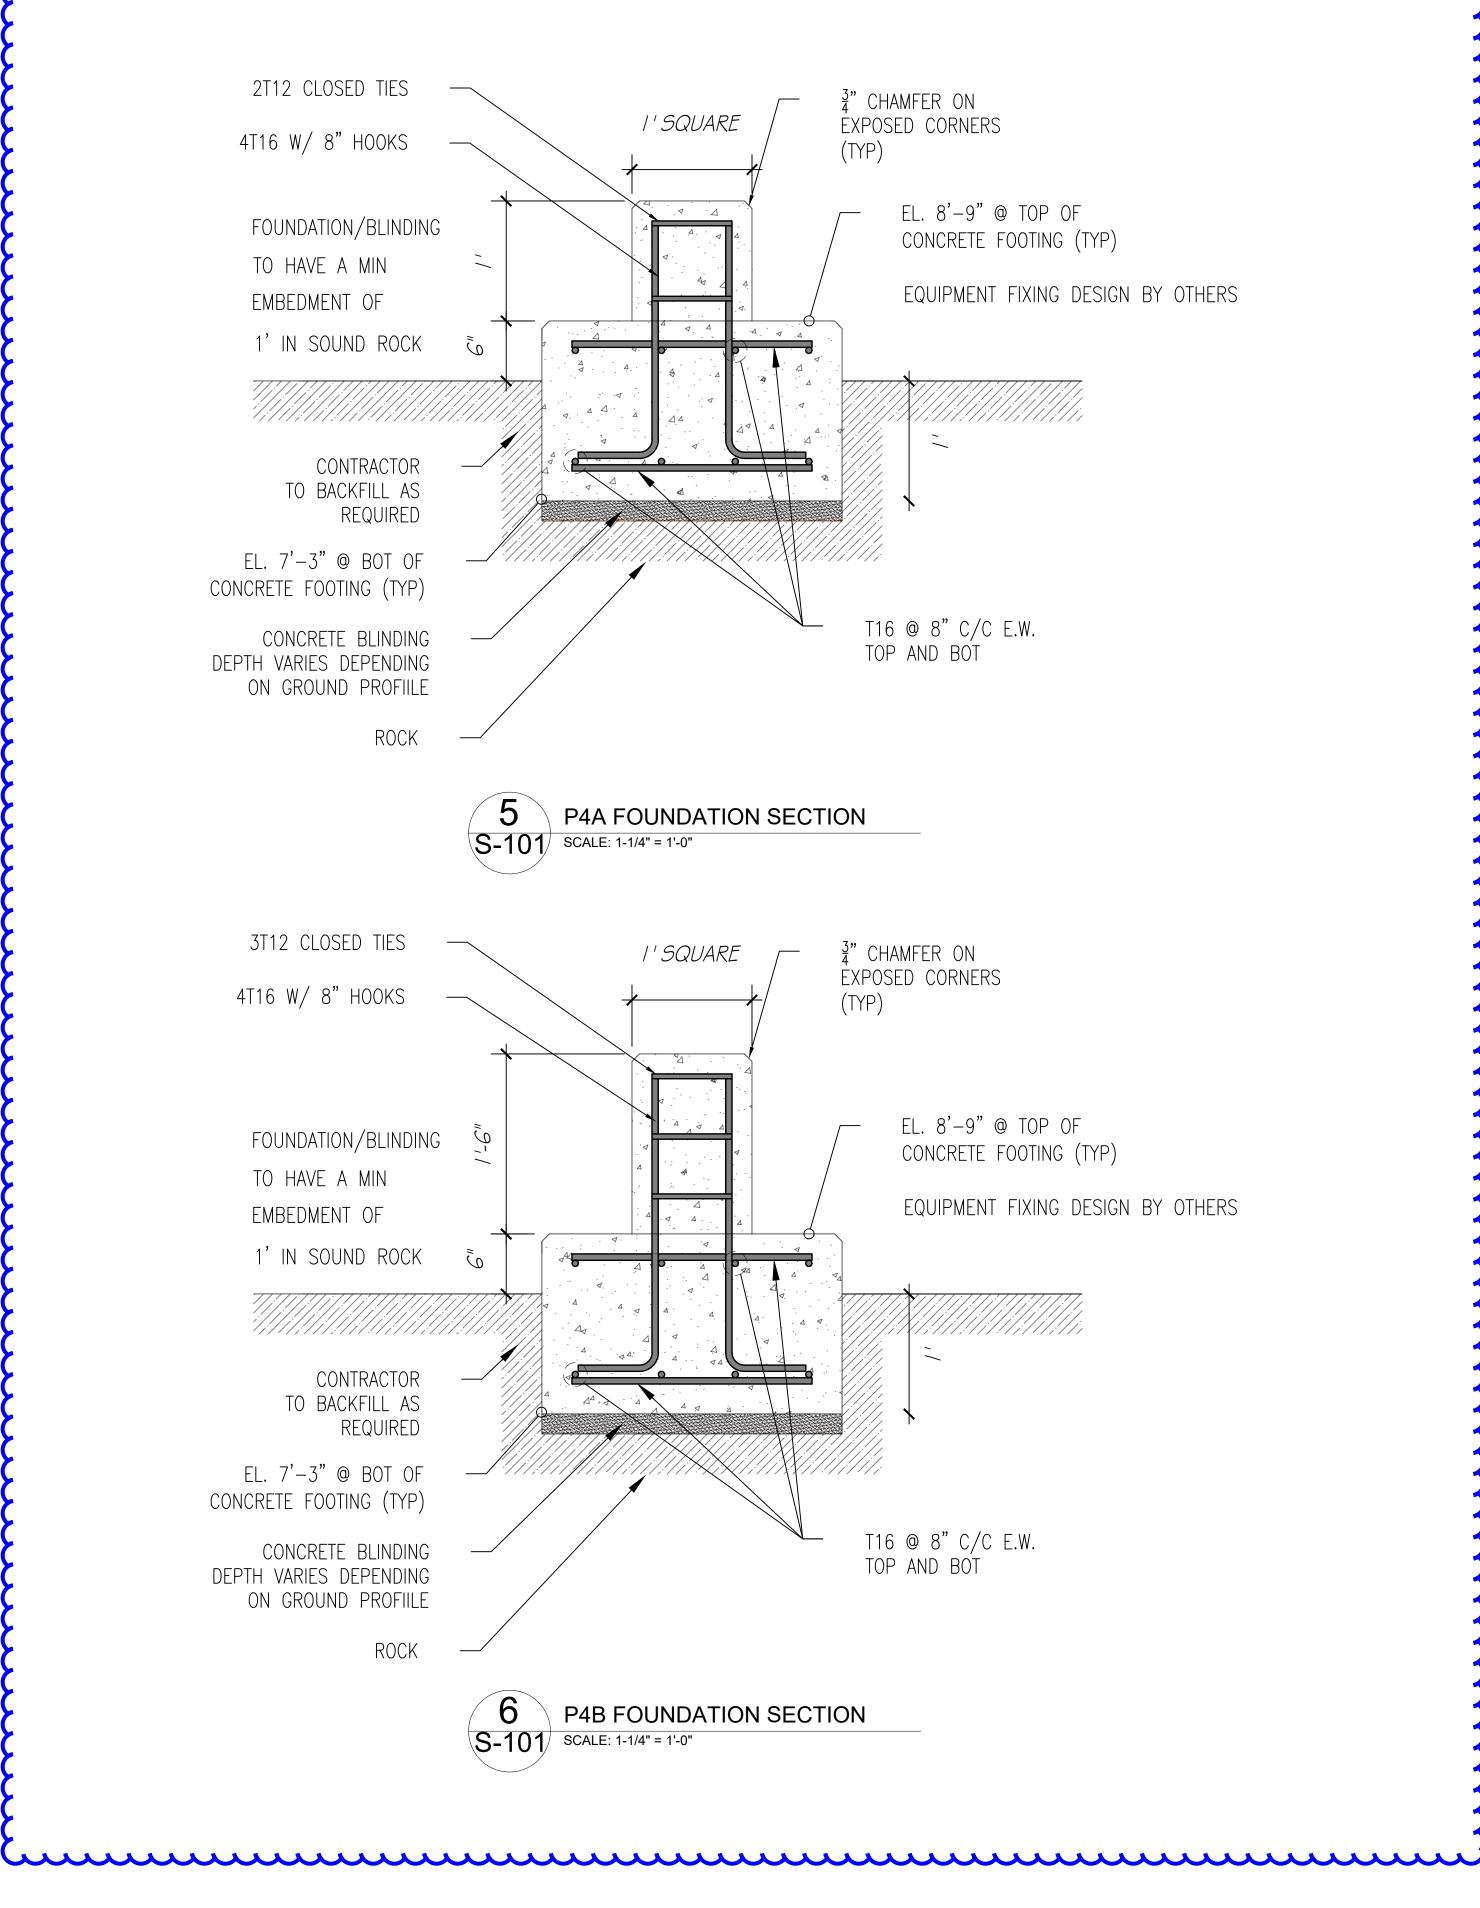

EL. 8'-9" @ TOP OF CONCRETE FOOTING (TYP) EQUIPMENT FIXING DESIGN BY OTHERS



ENGINEERING SERVICES 25 Serpentine Road, Pembroke HM 07 Phone: (441) 294-3693 Email: info@iepc.bm www.iepc.bm

PRELIMINARY

NOT TO BE USED FOR CONSTRUCTION

REVISIONS

	No.	DATE	BY	REVISION
	00	2024-08-09	RGW	ISSUED FOR PRELIMINARY PRICING
	01	2024-08-12	RGW	ISSUED FOR PRELIMINARY PRICING
ĺ				

PROJECT DETAILS

PUBLIC WORKS QUARRY & DEPOT QUARRY ROAD HAMILTON PARISH BERMUDA

TITLE

SCREENING PLANT PAD FOOTING FOUNDATION STRUCTURAL DETAILS

DESIGN BY: RGW

CHECKED BY: RB


JOB No:


REVISION:

DATE: 09-AUG-2024

SHEET No: 0


S-301

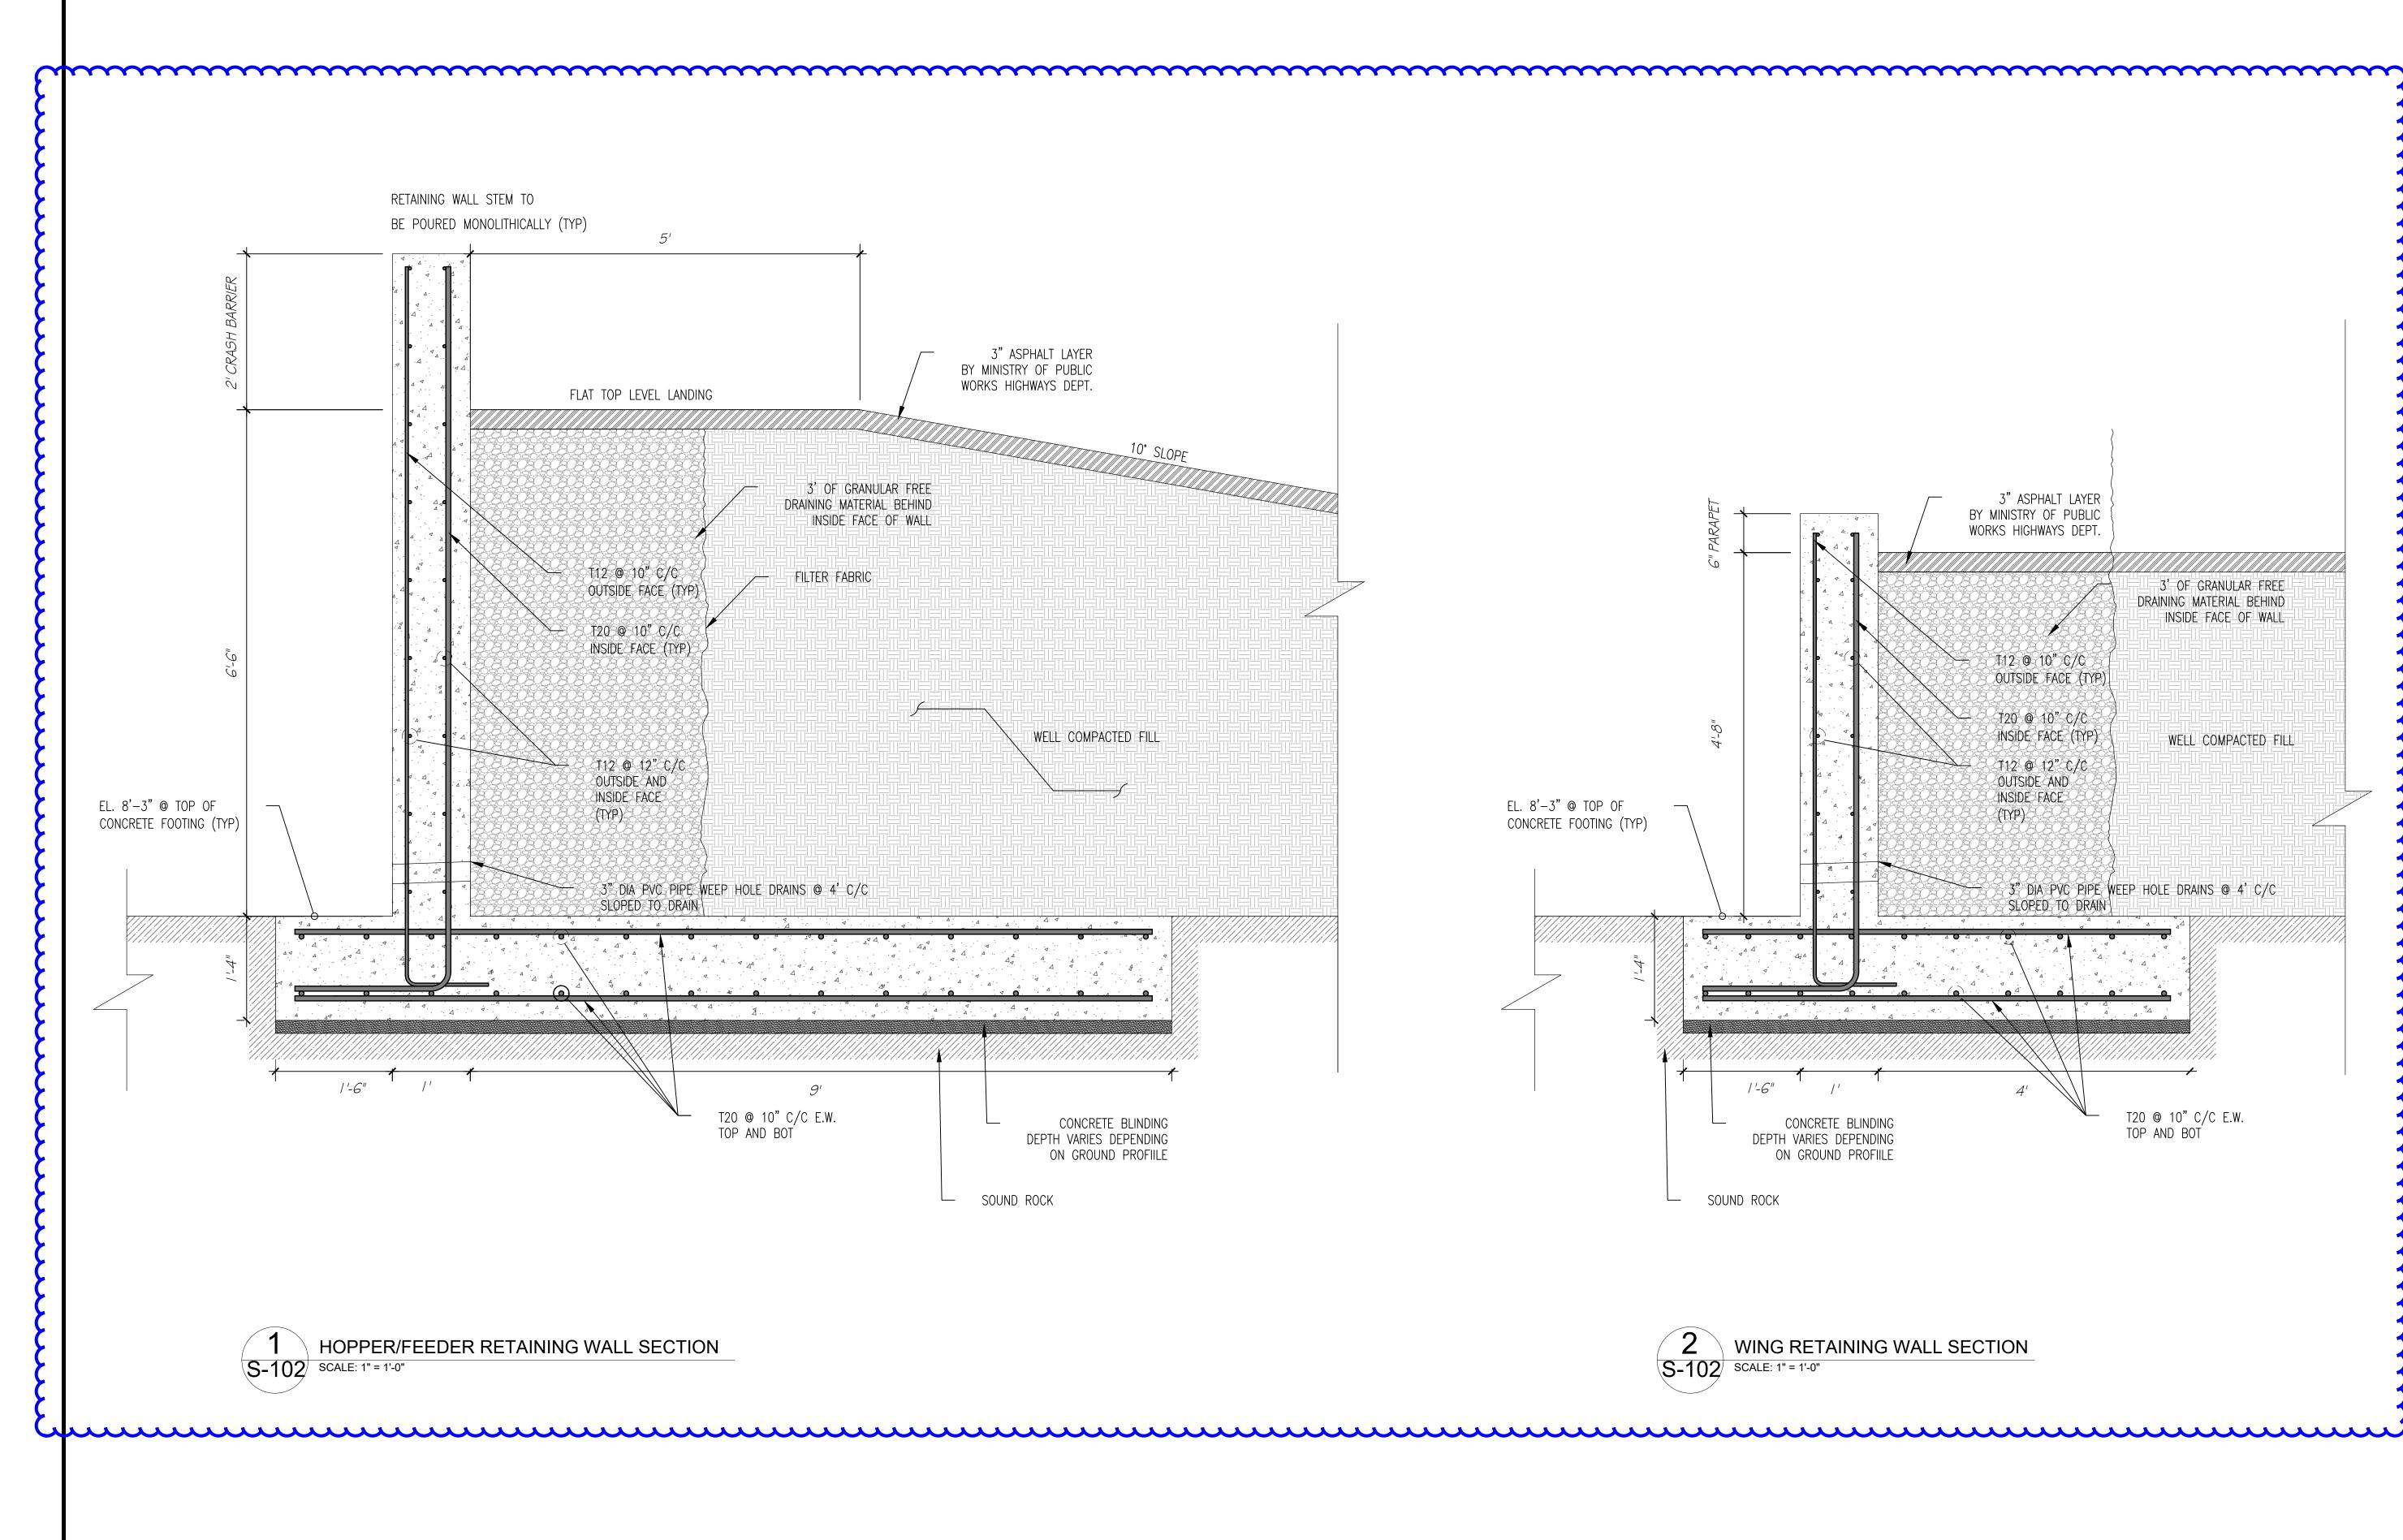


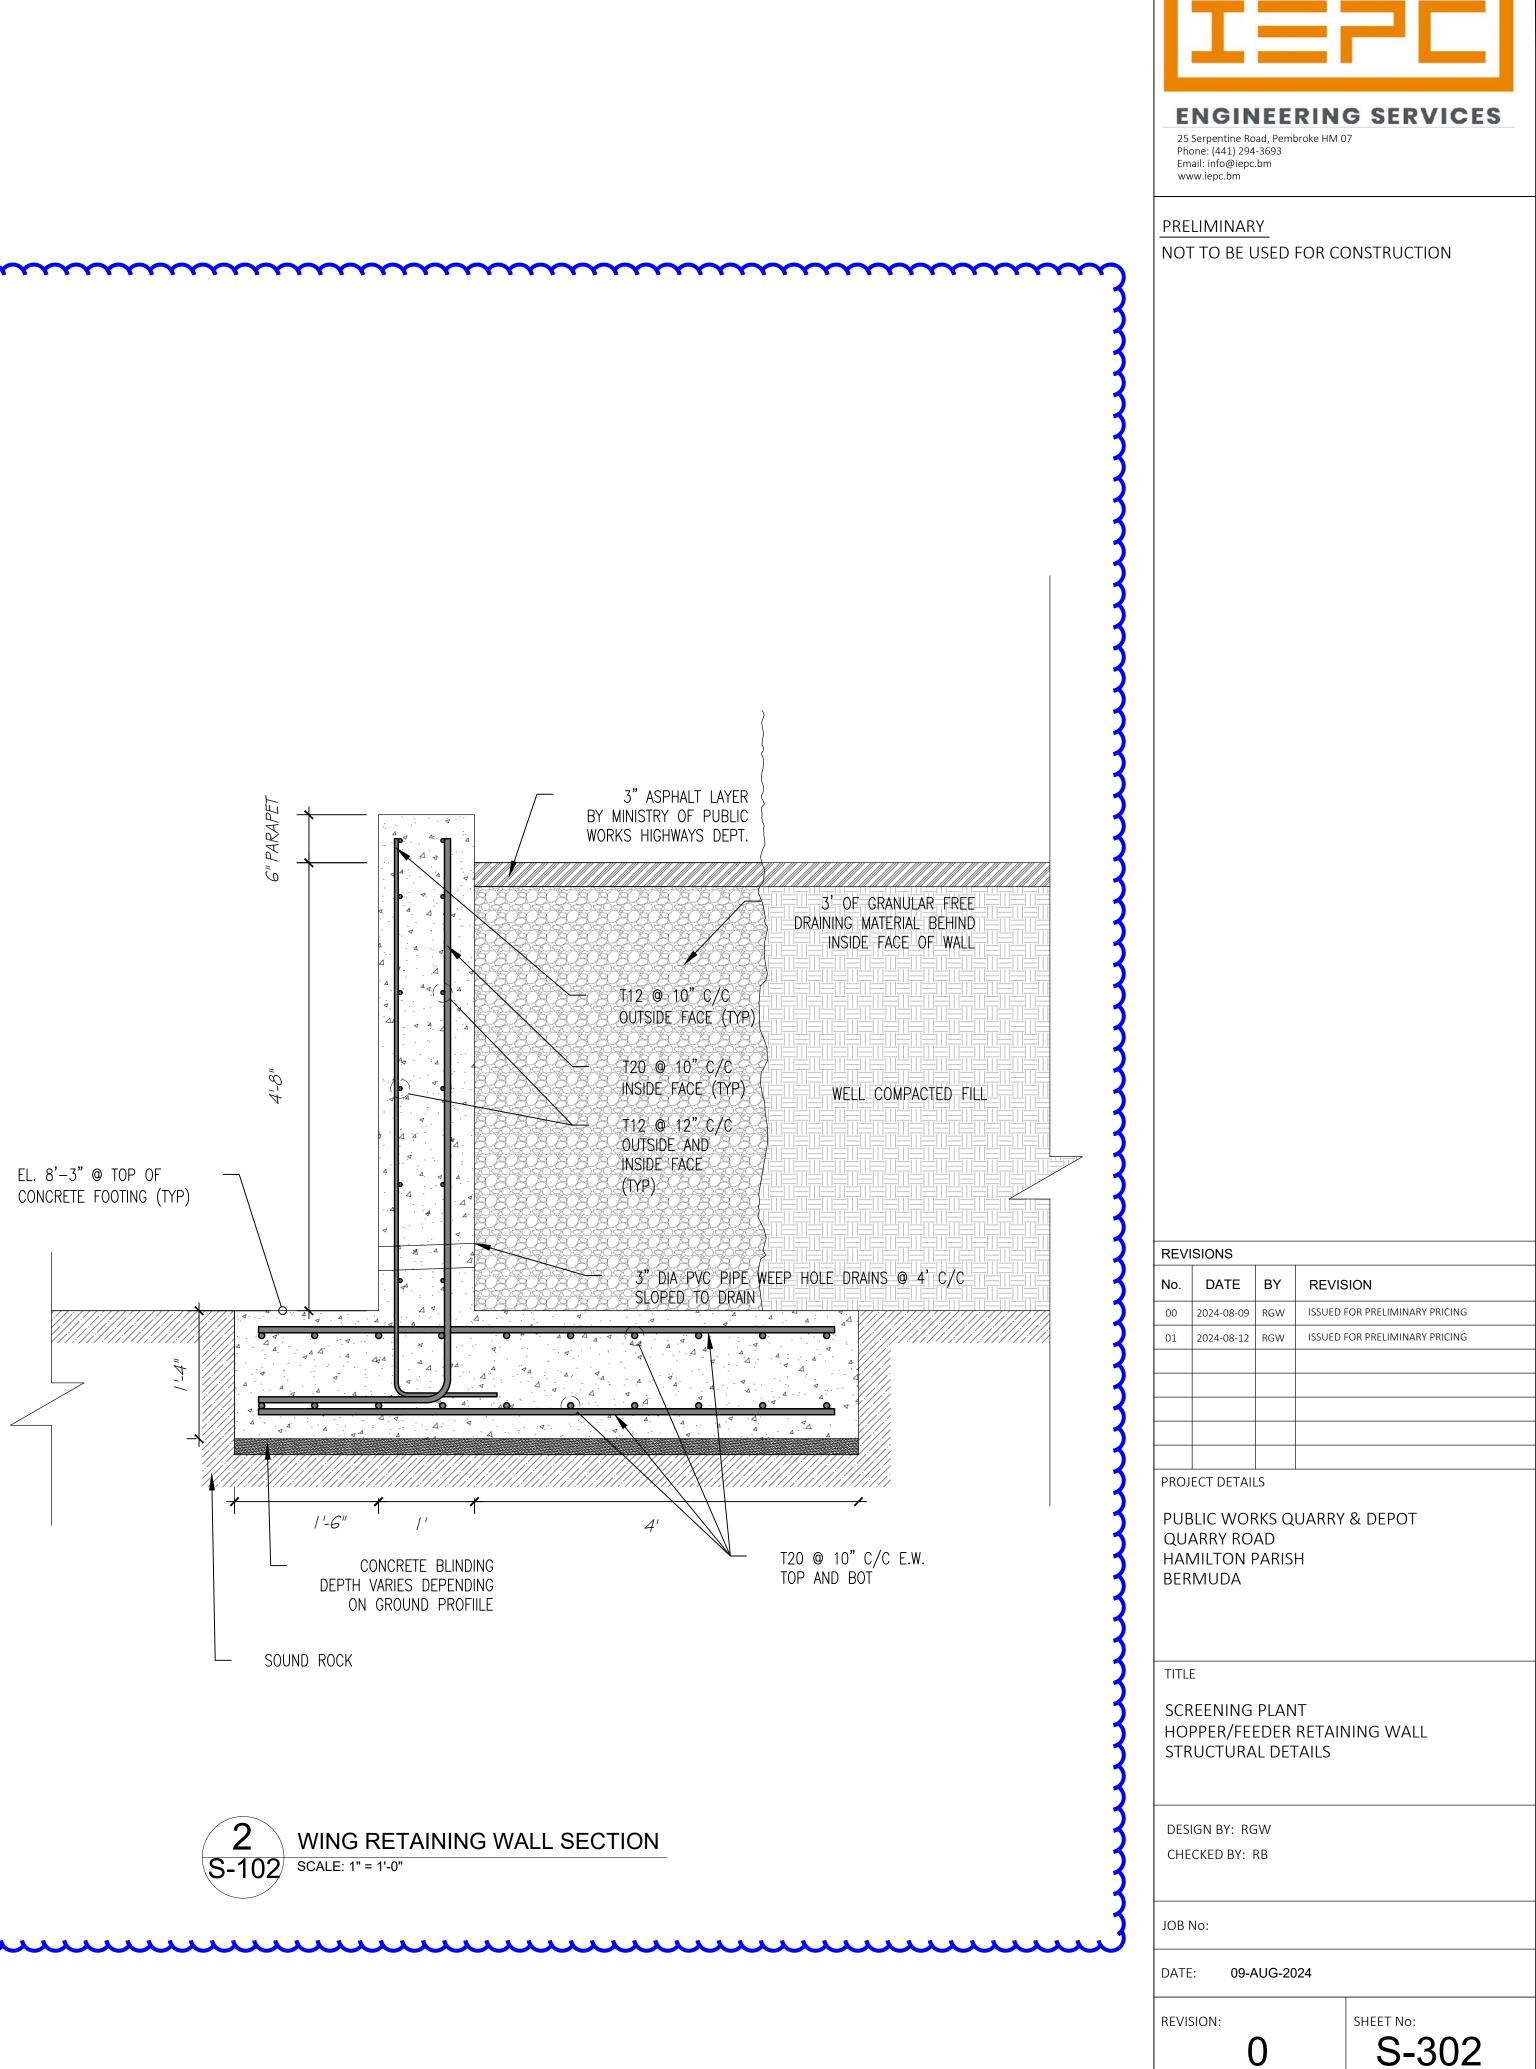


ENGINEERING CONSULTANTS:




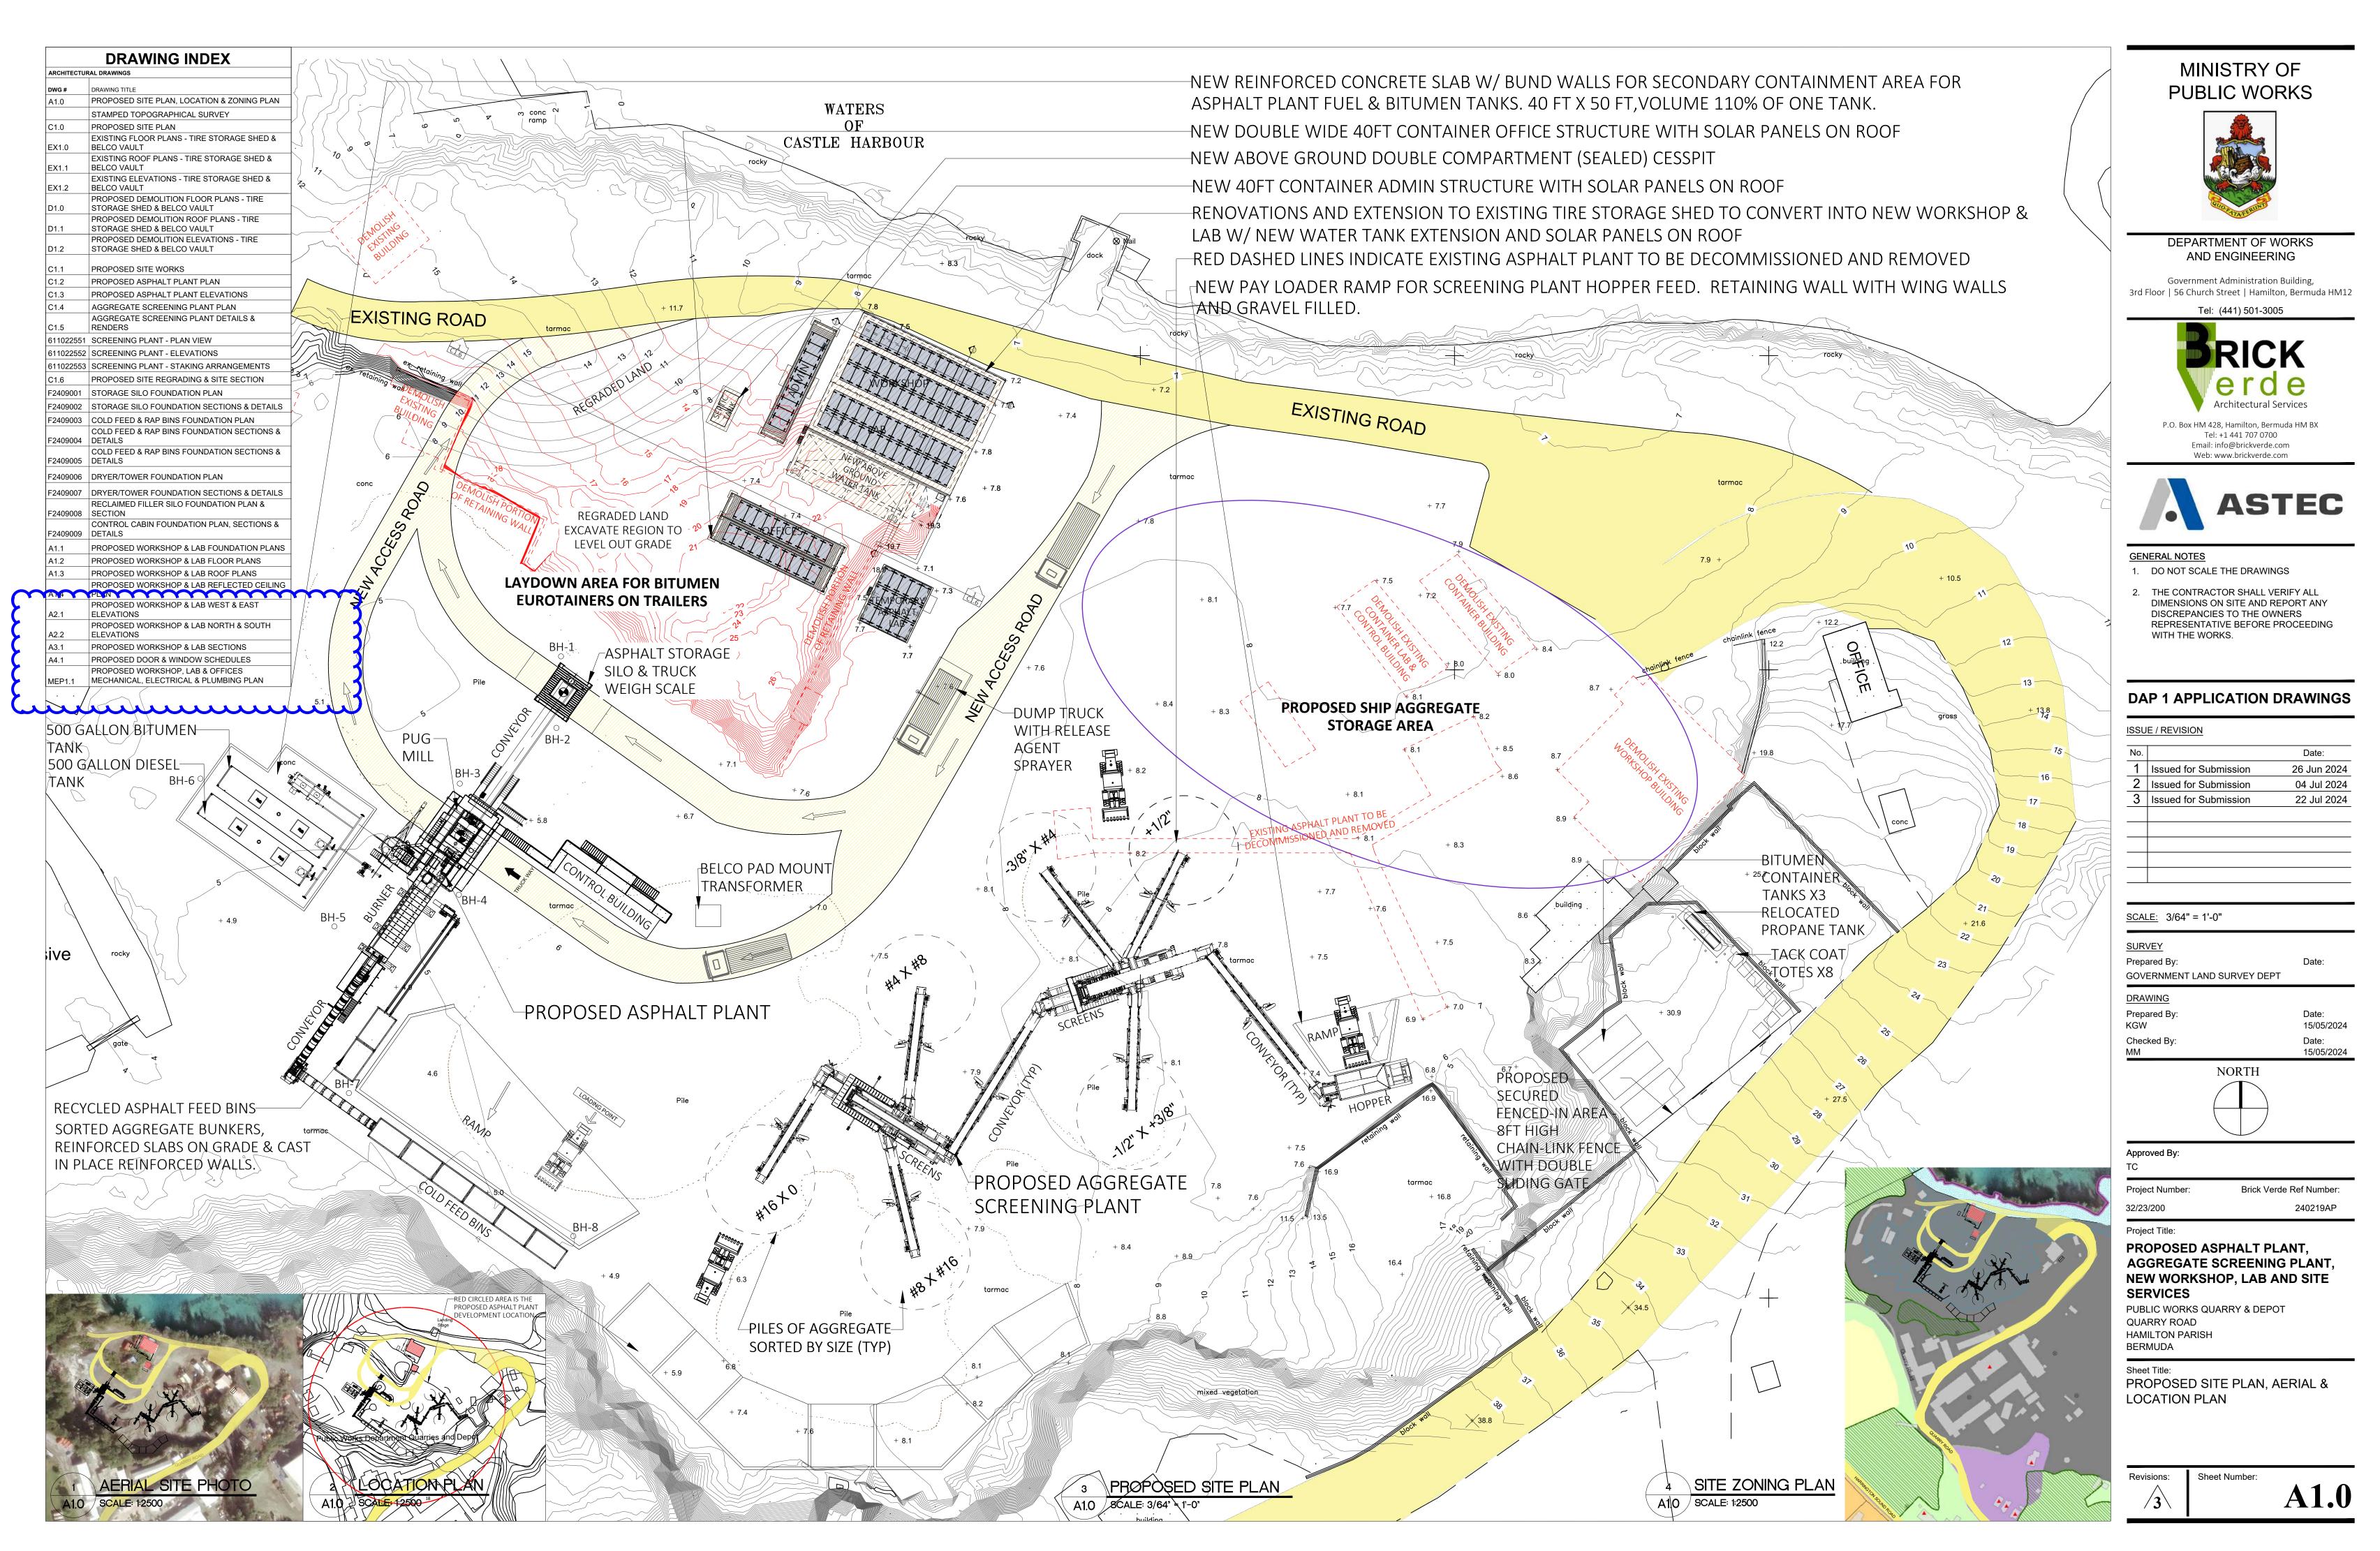

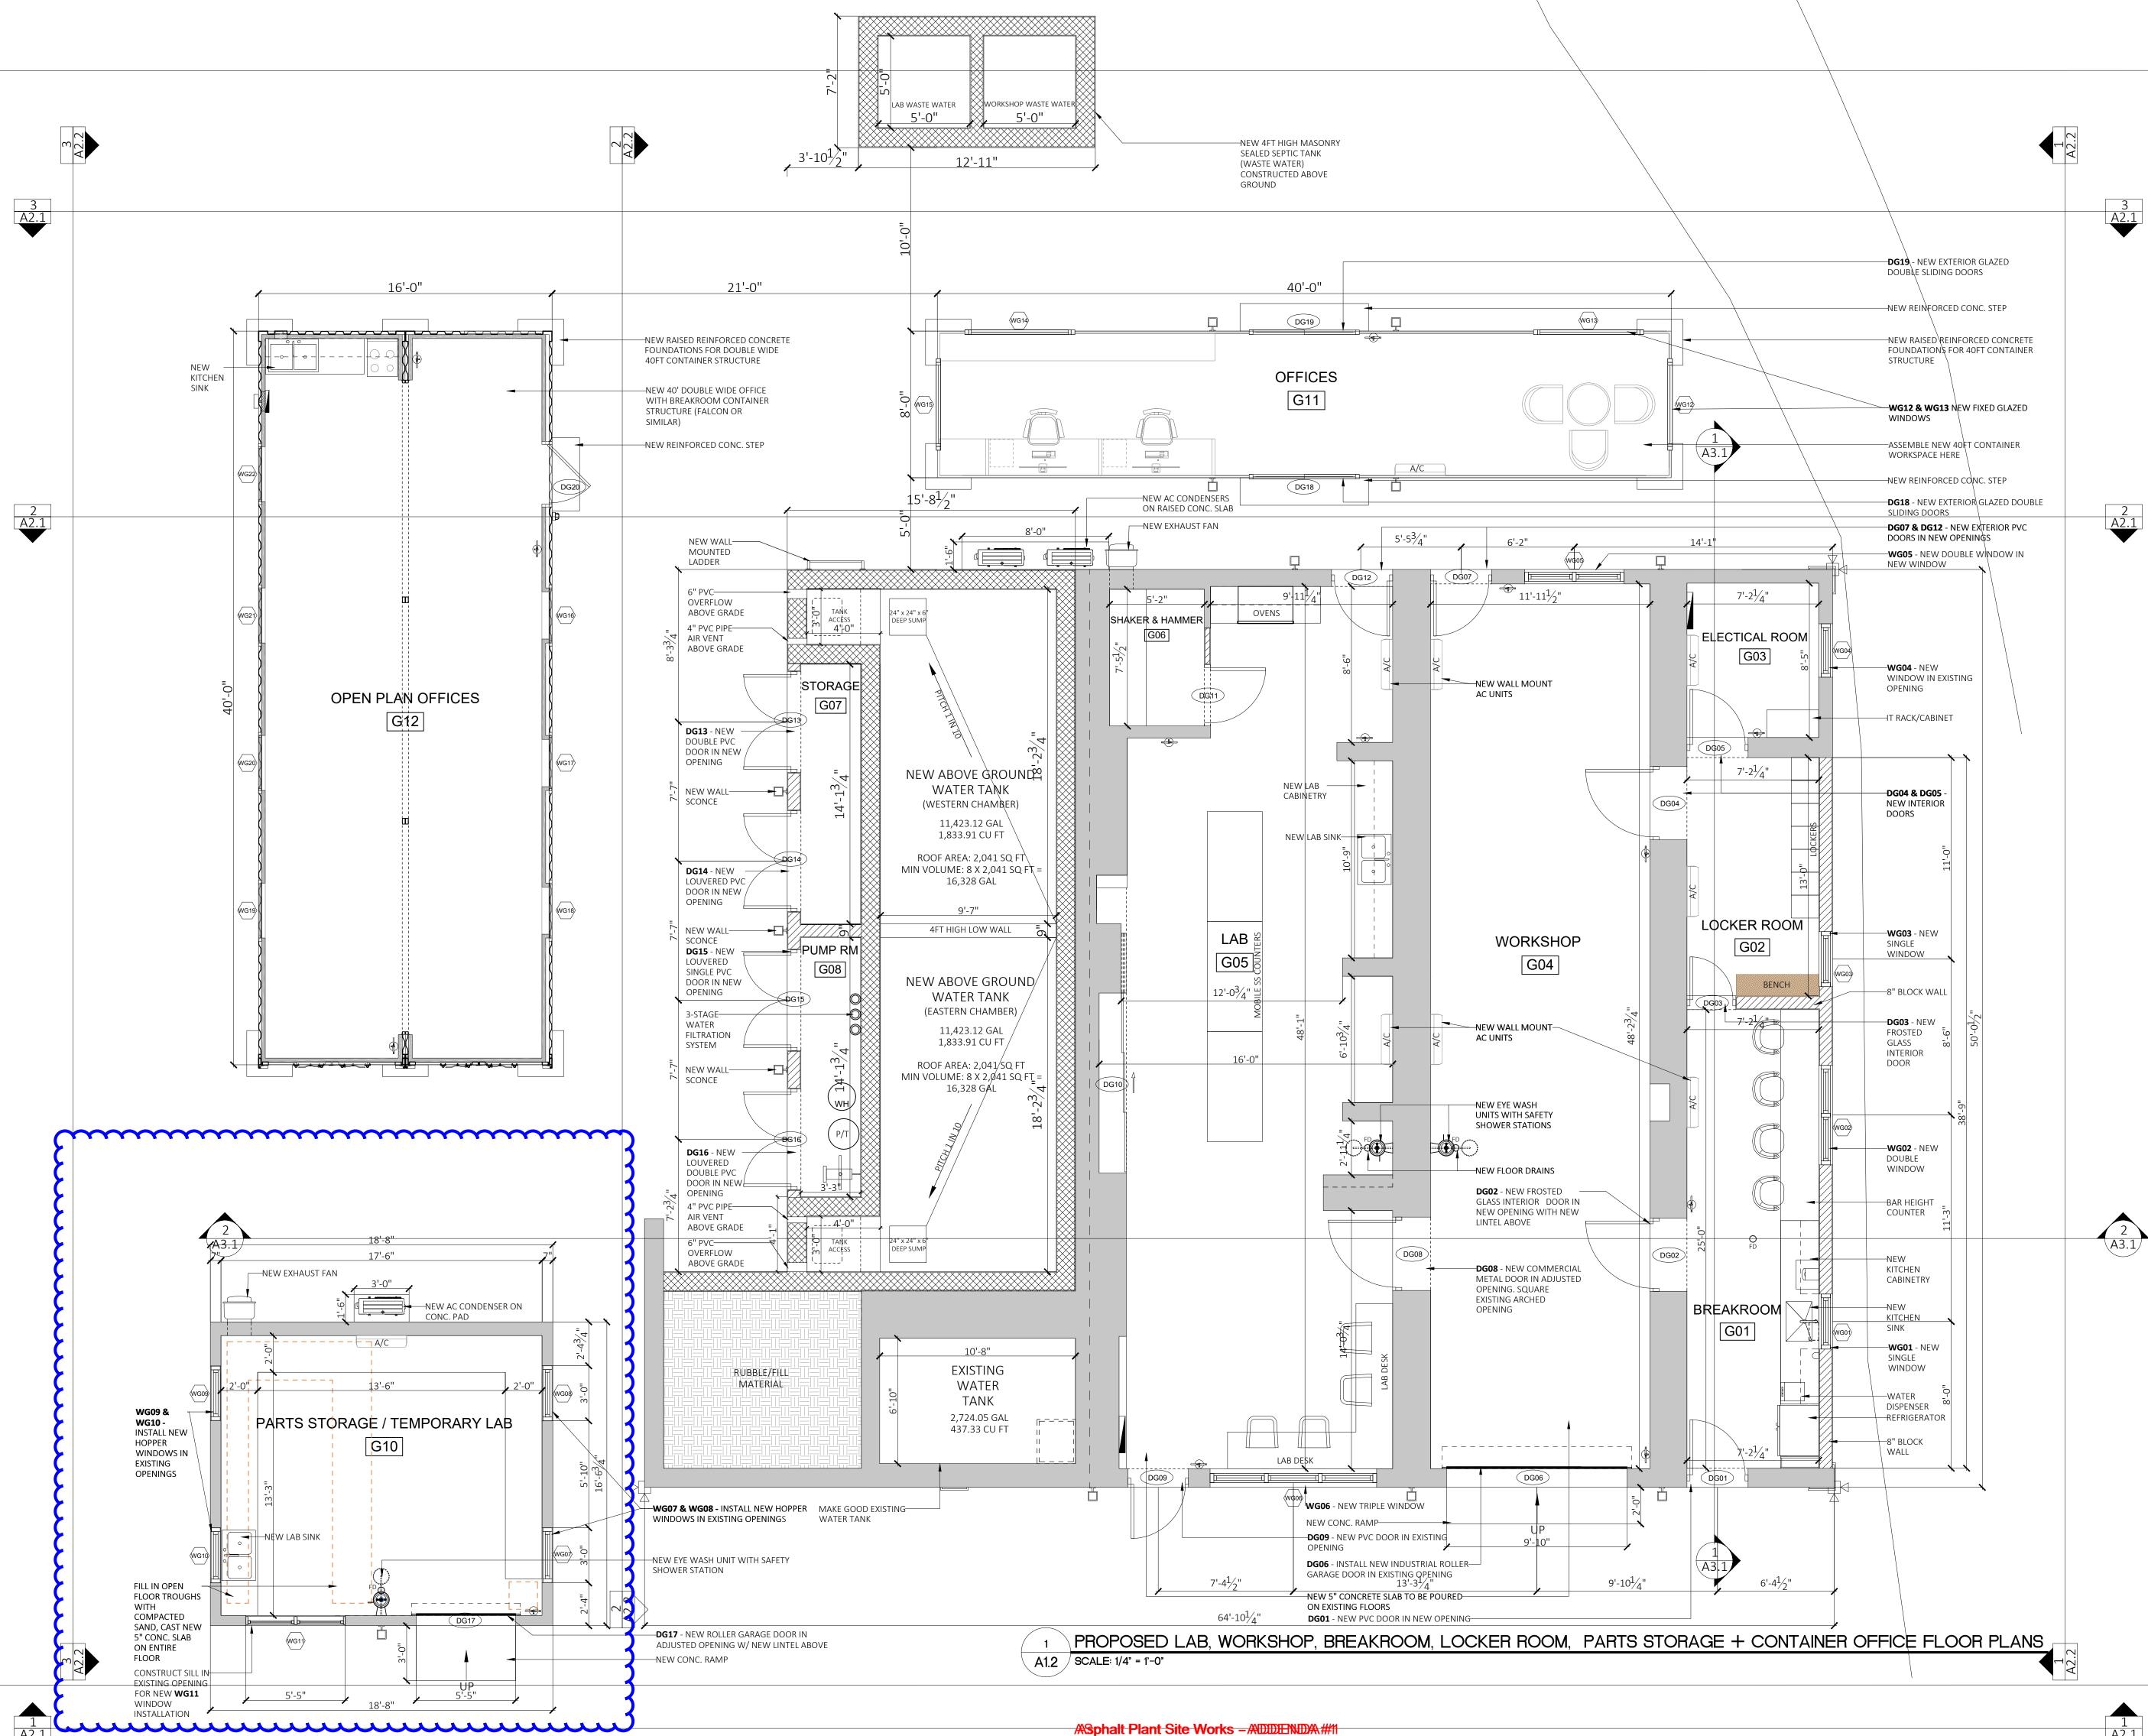


	F 〈S
DEPARTMENT OF WO AND ENGINEERING	
Government Administration Bu 3rd Floor 56 Church Street Hamilton, I Tel: (441) 501-3005	
P.O. Box HM 428, Hamilton, Bermuda Tel: +1 441 707 0700 Email: info@brickverde.com Web: www.brickverde.com	e
GENERAL NOTES	
 DO NOT SCALE THE DRAWINGS THE CONTRACTOR SHALL VERIF DIMENSIONS ON SITE AND REPO DISCREPANCIES TO THE OWNER REPRESENTATIVE BEFORE PRO WITH THE WORKS. 	ORT ANY RS
ISSUE / REVISION No. Issued for DAP 1 Submission 2 Issued for DAP 1 Submission 3 Issued for DAP 1 Submission	22 July 202
	26 July 202
	26 July 202
	26 July 202
<u>SCALE:</u> 1/4" = 1'-0" <u>SURVEY</u> Prepared By:	Date:
SCALE: 1/4" = 1'-0" SURVEY Prepared By: GOVERNMENT LAND SURVEY DEPT DESIGN Prepared By:	Date:
SCALE: 1/4" = 1'-0" SURVEY Prepared By: GOVERNMENT LAND SURVEY DEPT DESIGN	Date:
SCALE: 1/4" = 1'-0" SURVEY Prepared By: GOVERNMENT LAND SURVEY DEPT DESIGN Prepared By: KGW Checked By:	Date: 15/05/202 Date:
SCALE: 1/4" = 1'-0" SURVEY Prepared By: GOVERNMENT LAND SURVEY DEPT DESIGN Prepared By: KGW Checked By: MM DRAWING Prepared By: KGW Checked By: KGW	Date: 15/05/202 Date: 15/05/202 Date: 15/05/202 Date: 15/05/202 Date:
SCALE: 1/4" = 1'-0" SURVEY Prepared By: GOVERNMENT LAND SURVEY DEPT DESIGN Prepared By: KGW Checked By: MM DRAWING Prepared By: KGW Checked By: MM	Date: 15/05/202 Date: 15/05/202 Date: 15/05/202 Date: 15/05/202 Date:
SCALE: 1/4" = 1'-0" SURVEY Prepared By: GOVERNMENT LAND SURVEY DEPT DESIGN Prepared By: KGW Checked By: MM DRAWING Prepared By: KGW Checked By: MM Approved By: TC	Date: Date: 15/05/202 Date: 15/05/202 Date: 15/05/202 Date: 15/05/202
SCALE: 1/4" = 1'-0" SURVEY Prepared By: GOVERNMENT LAND SURVEY DEPT DESIGN Prepared By: KGW Checked By: MM DRAWING Prepared By: KGW Checked By: MM Approved By:	Date: 15/05/20 Date: 15/05/20 Date: 15/05/20 Date:
SCALE: 1/4" = 1'-0" SURVEY Prepared By: GOVERNMENT LAND SURVEY DEPT DESIGN Prepared By: KGW Checked By: MM DRAWING Prepared By: KGW Checked By: MM	Date: 15/05/20 Date: 15/05/20 Date: 15/05/20 Date: 15/05/20 Ref Number 240219AP NT, PLANT, D SITE

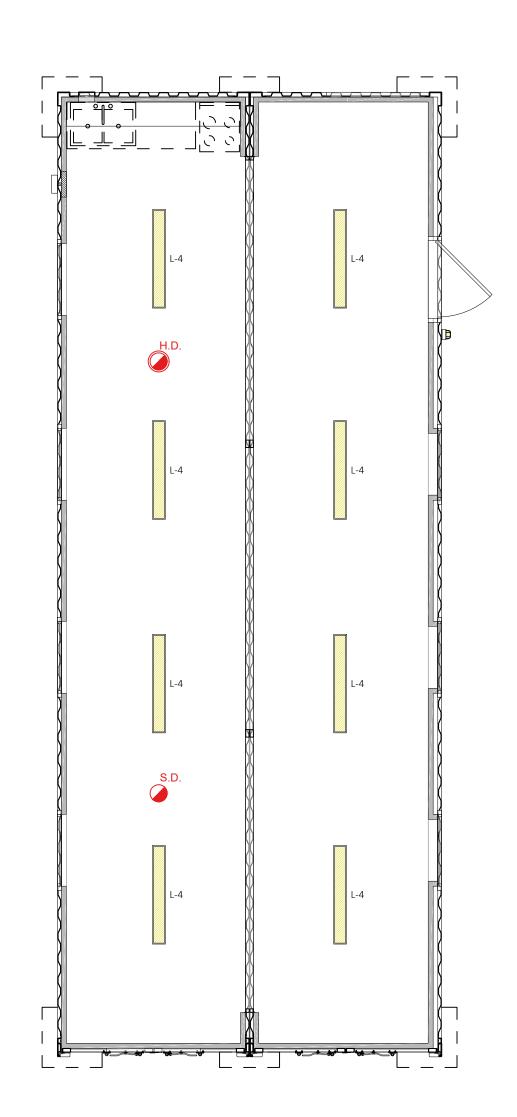

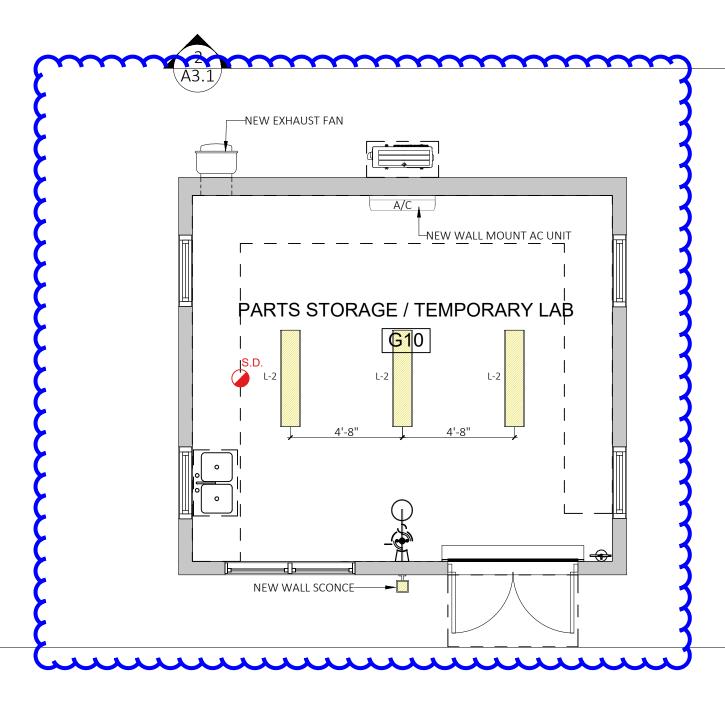

NEW FLOOD SECURITY LIGHTS


RUBBLE/FILL MATERIAL

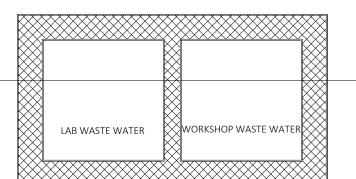





	_		
	Pl		1273
	DEI	PARTMENT OF W	-
3rd I		AND ENGINEERIN ernment Administration Church Street Hamilton	Building,
		Tel: (441) 501-3005	5
		PRIC	
	P.O. Bo	Architectural Se ox HM 428, Hamilton, Bermu Tel: +1 441 707 0700	ervices
		Email: info@brickverde.cc Web: www.brickverde.co	
			A
<u>GEN</u> 1.	<u>NERAL NC</u> DO NOT	SCALE THE DRAWING	S
2.	DIMENS DISCRE REPRES	NTRACTOR SHALL VE IONS ON SITE AND RE PANCIES TO THE OWN SENTATIVE BEFORE PF HE WORKS.	PORT ANY IERS
No. 1 2 3 4	Issued f	for DAP 1 Submission for DAP 1 Submission for DAP 1 Submission for Tender	22 Jul 2024
SCAI	<u>LE:</u> 1/4"	= 1'-0"	
•	ared By:	T LAND SURVEY DEPT	Date:
<u>DESI</u> Prepa	I <u>GN</u> ared By:		Date:
KGŴ Chec	•		15/05/2024 Date:
	WING		15/05/2024
KGŴ			Date: 15/05/2024 Date:
MM	ked By:		Date: 15/05/2024
Appro TC	oved By:		
Proje 32/23	ect Numbe 3/200	r: Brick Verd	e Ref Number: 240219AP
-	ect Title:		
AG NE\	GREG	ED ASPHALT PLA ATE SCREENING RKSHOP, LAB A S	G PLANT,
qua Ham	LIC WOR RRY RO/ IILTON P/ MUDA		Г
PR(BRI ST(EAKRC	ED LAB, WORKSI OM, LOCKER RO & CONTAINER	OOM, PART
RE		ED CEILING PLA	

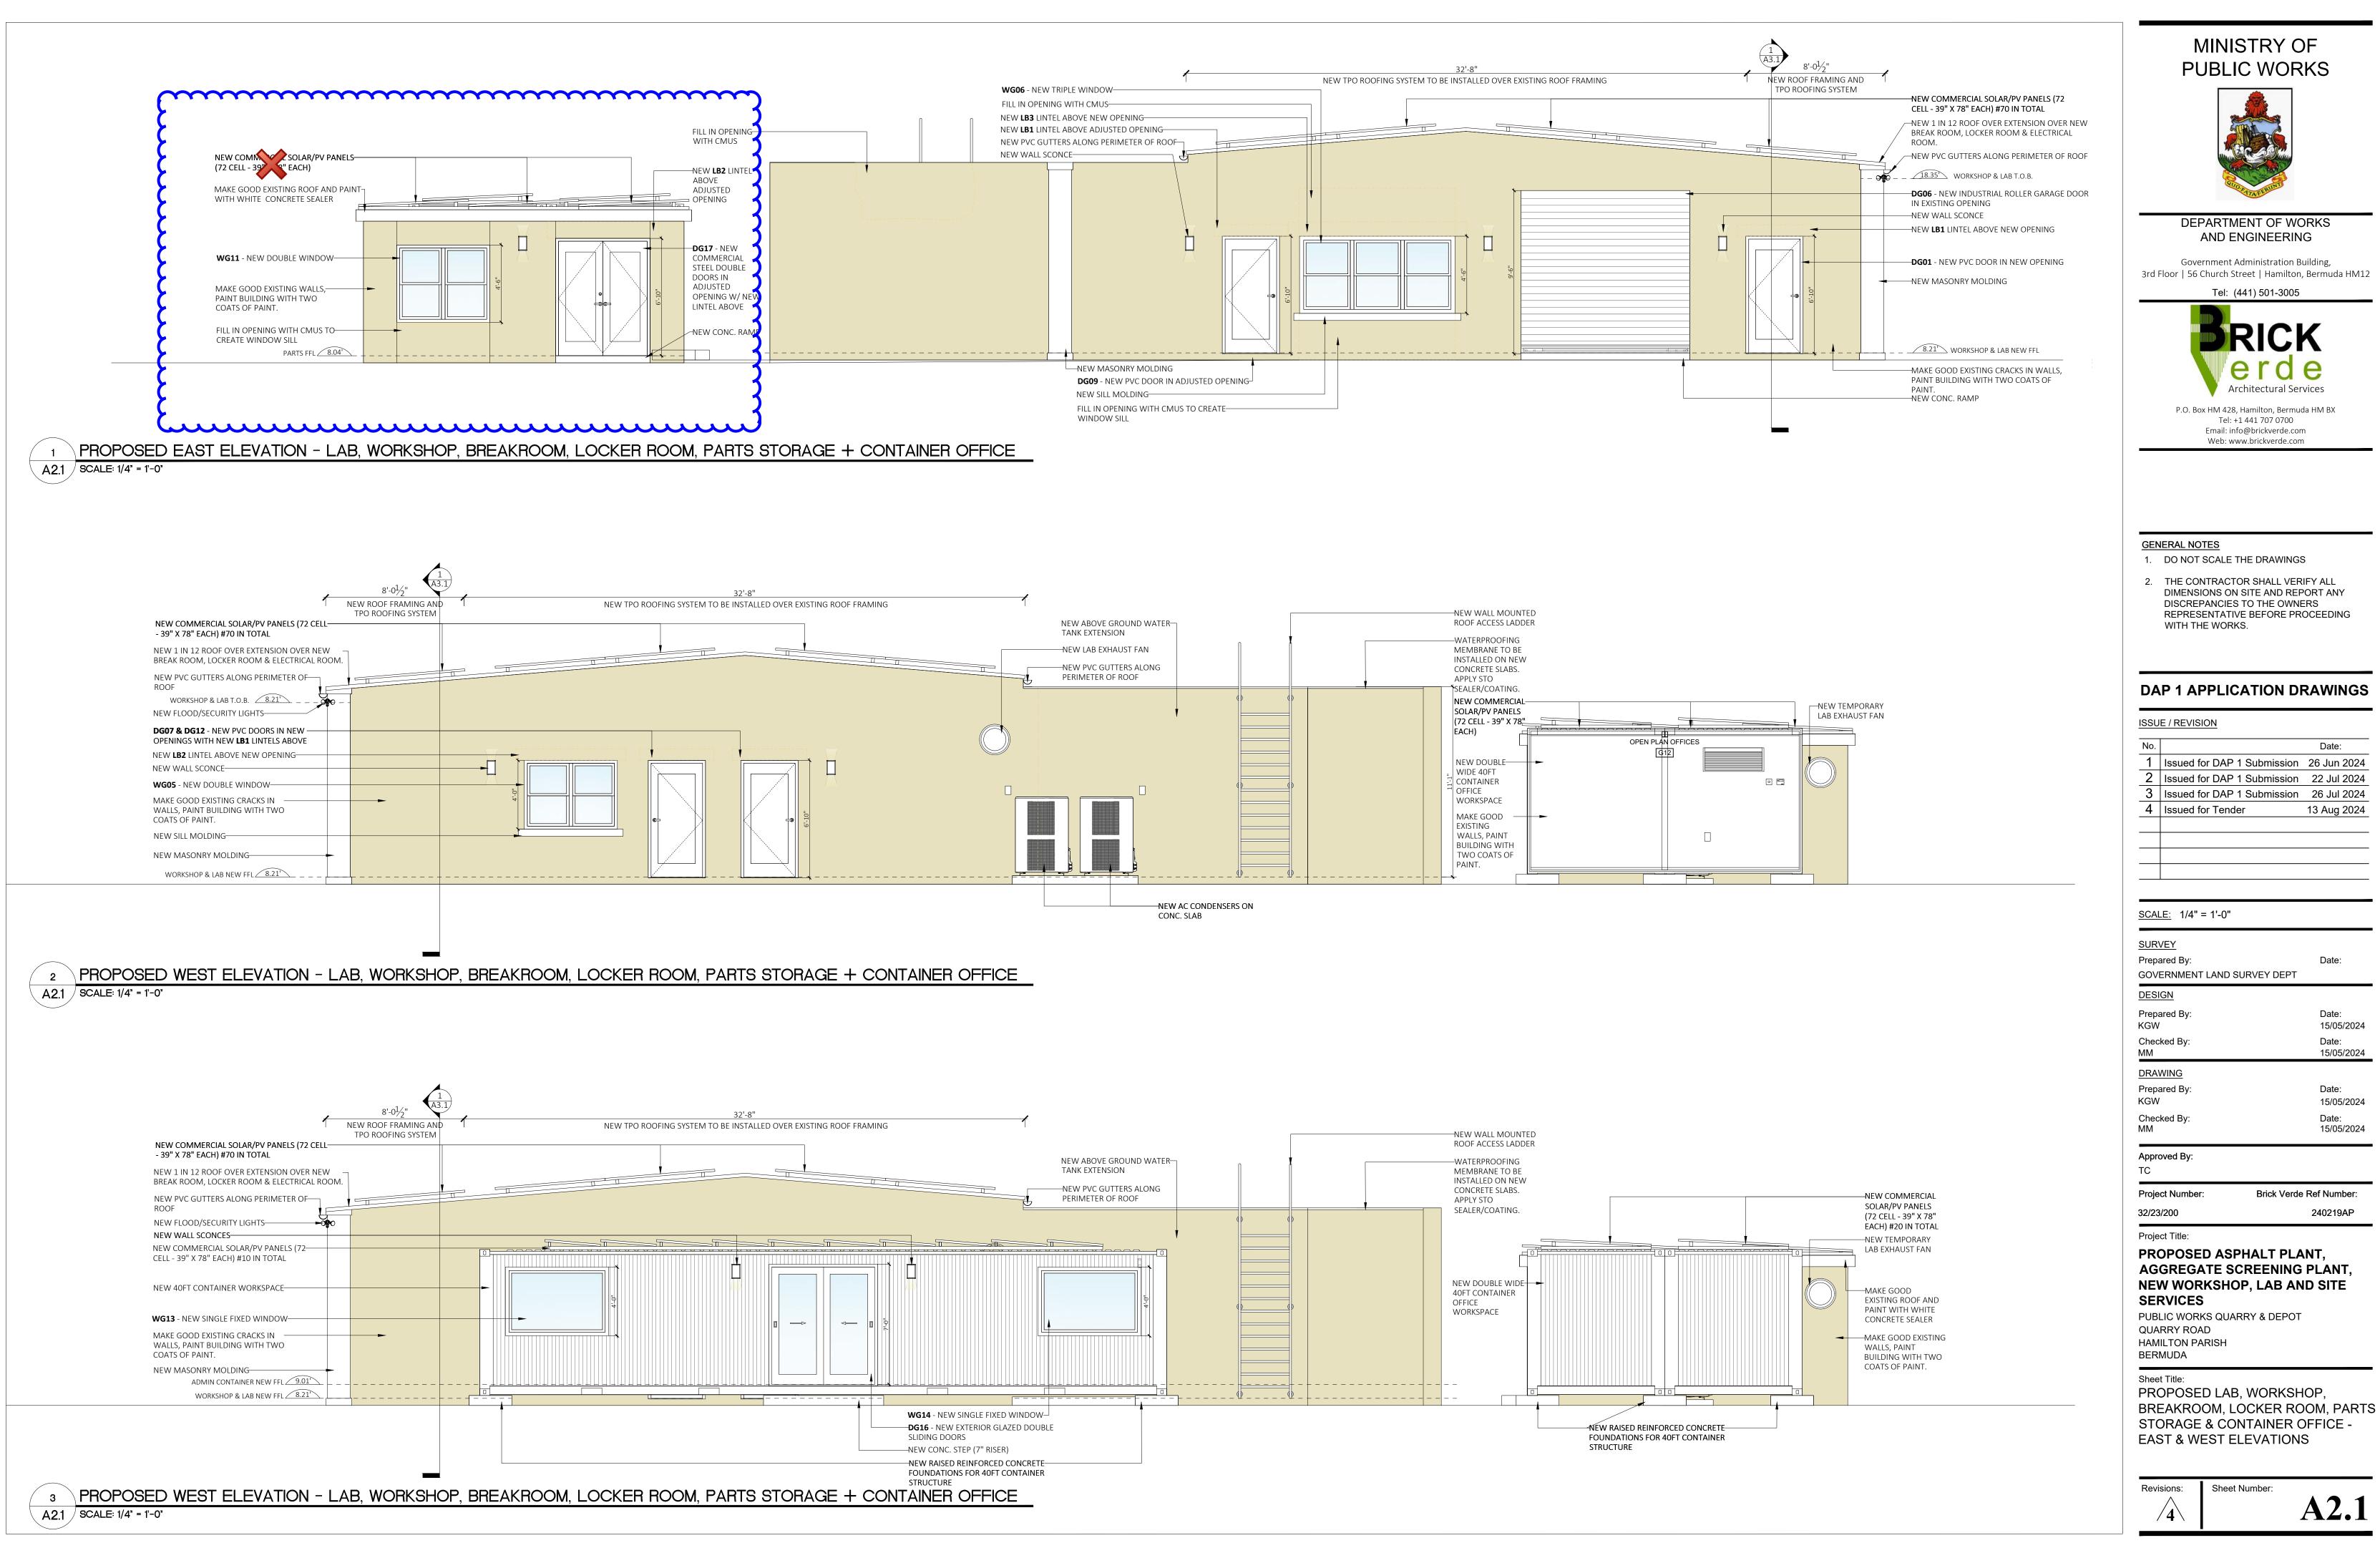

Revisions:	Sheet Number:	
		A2.1

Date:

13 Aug 2024

Date: 15/05/2024

Date: 15/05/2024

Date:


Date:

240219AP

15/05/2024


15/05/2024

DOOR SCHEDULE

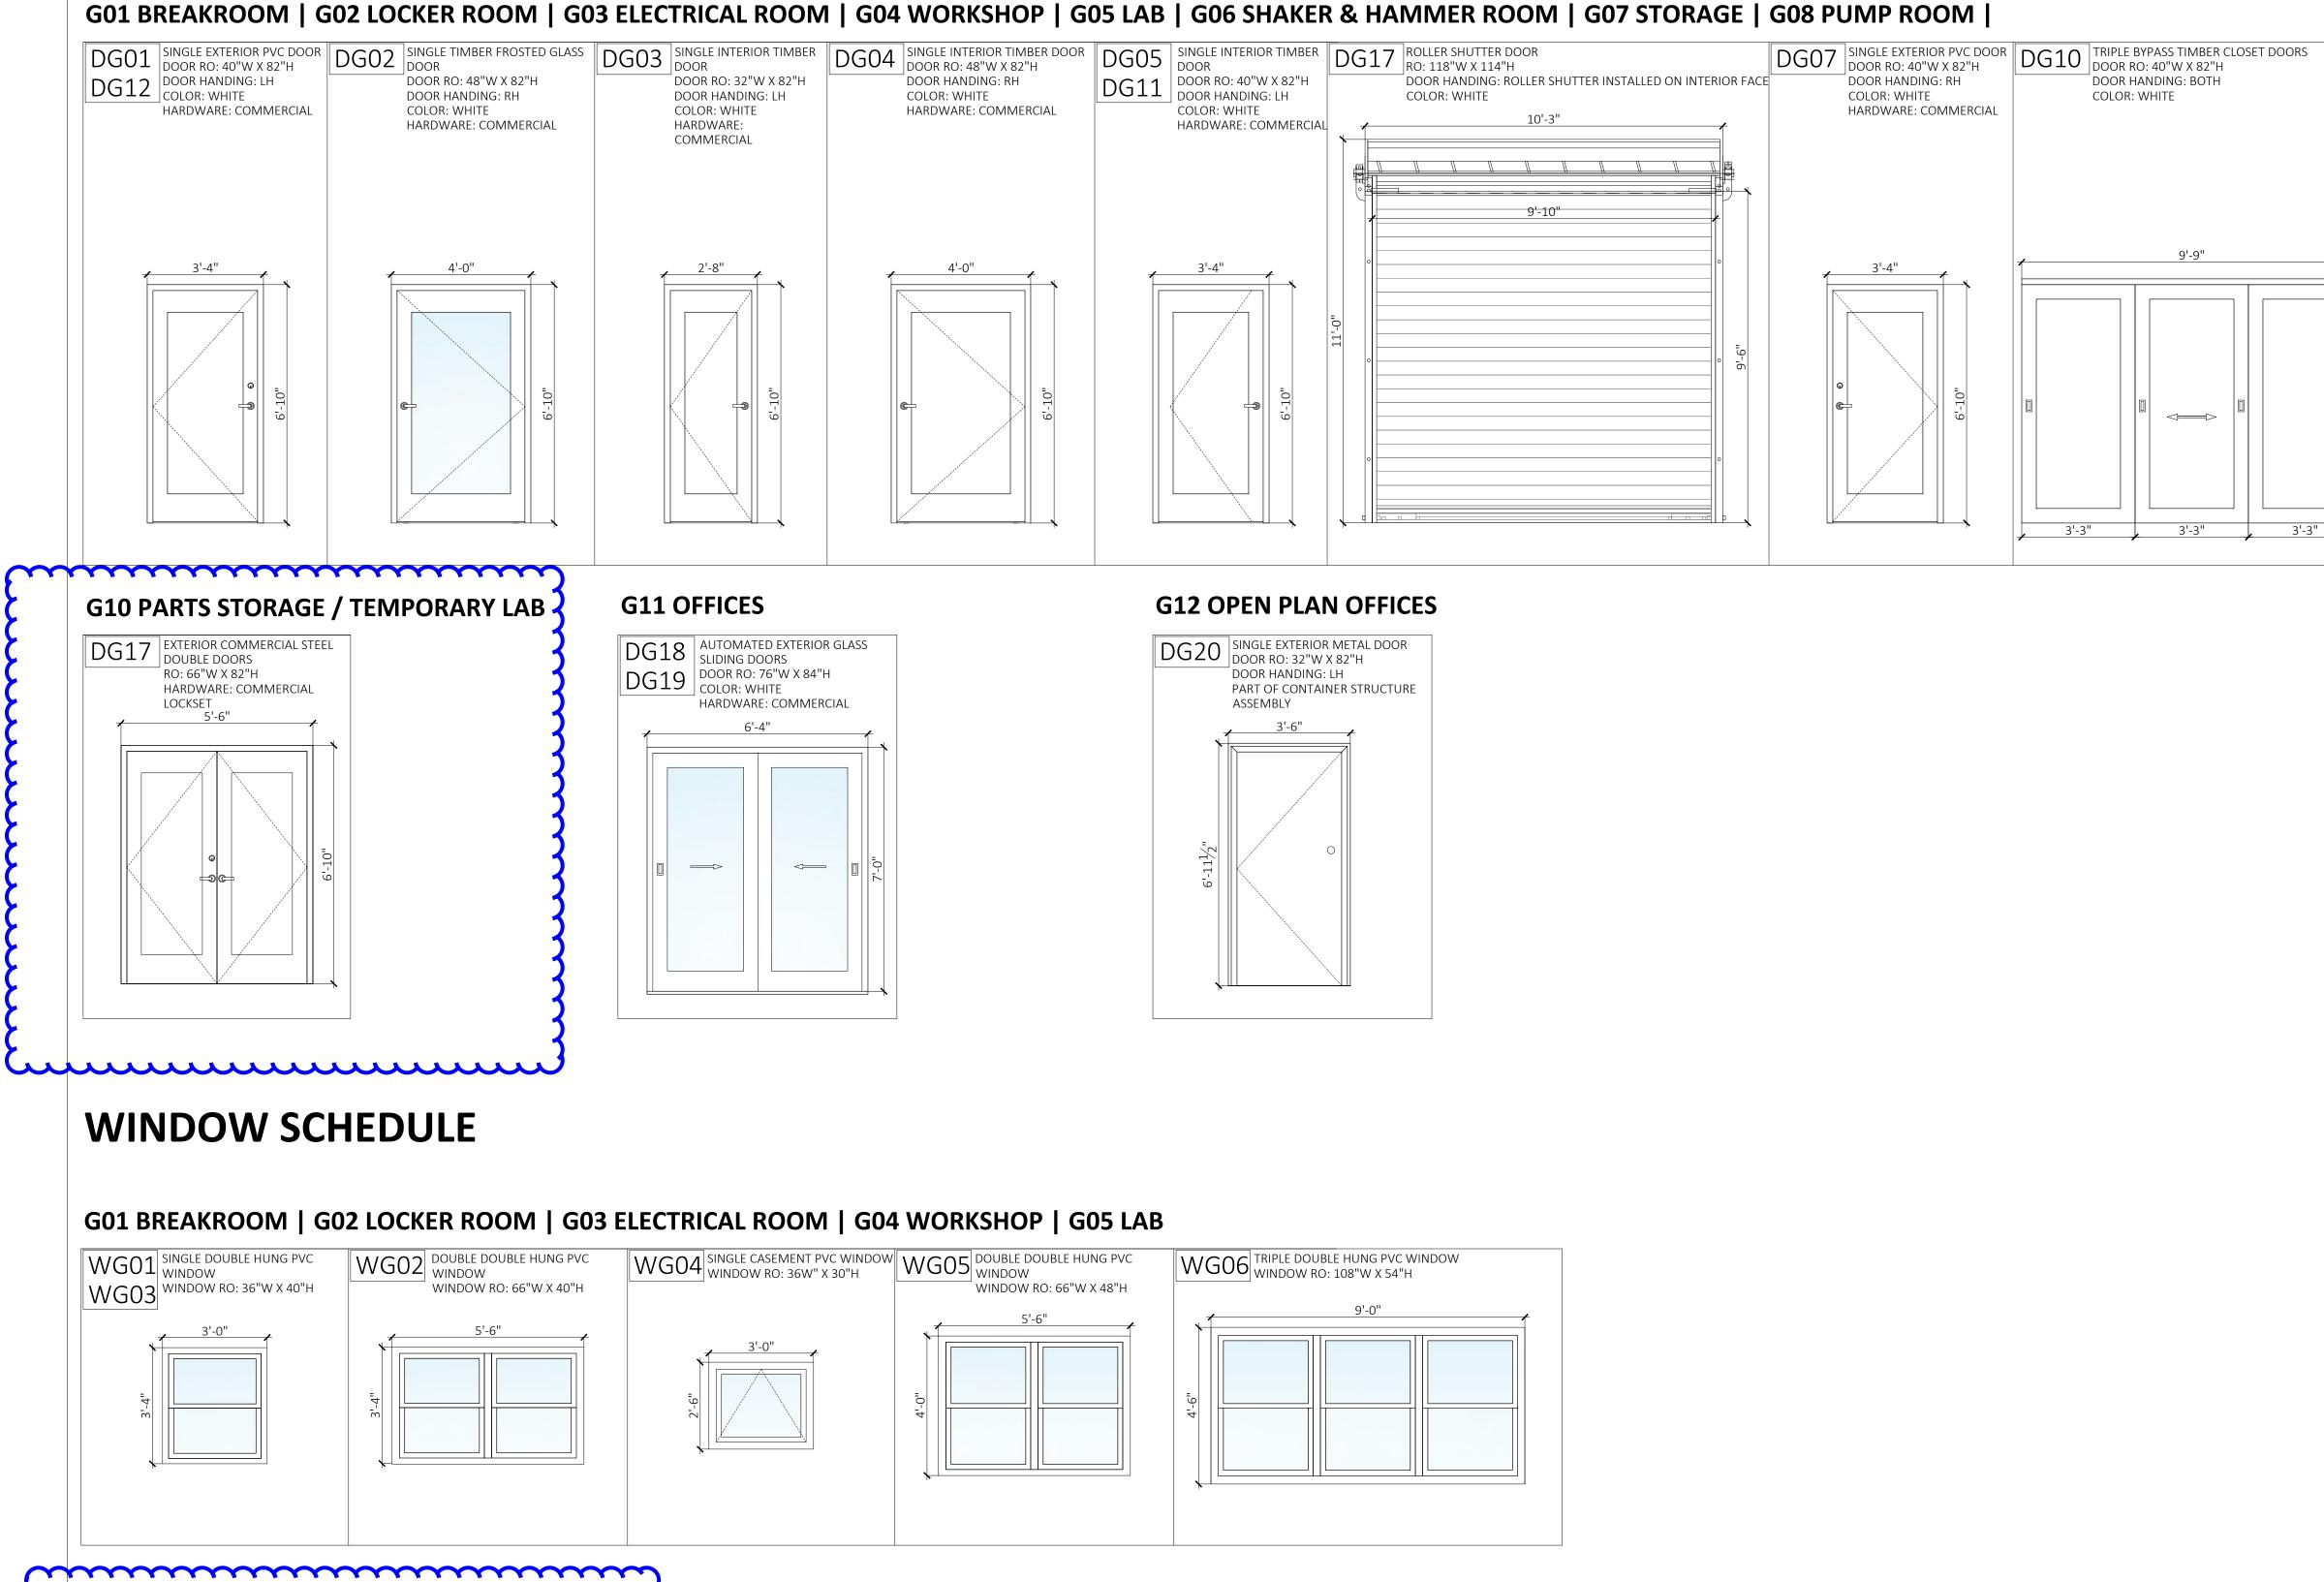

G10 PARTS STORAGE / TEMPORARY LAB WG07 HOPPER PVC WINDOW WINDOW RO: 36"W X 18"H

WG08 WG09 WG10

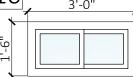


WG	11 DOUBLE DOUBLE HUNG PVC WINDOW (IMPACT RESISTANT) WINDOW RO: 66"W X 54"H
+	5'-6"
4'-6"	

G11 OFFICES

WG1	2 FIXED SINGLE PVC WINDOW WINDOW RO: 60"W X 48"H	WG13	FIXED SINGLE PV WINDOW RO: 72
WG1	.5	WG14	
4'-0"	5'-0"	4 ¹⁻⁰ "	6'-0"

G12 OPEN PLAN OFFICES

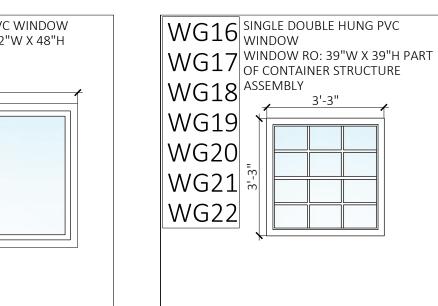

	G13 G14 DOUBLE EXTERIOR PVC UTILITY DOOR RO: 40"W X 82"H DOOR HANDING: BOTH COLOR: WHITE HARDWARE: COMMERCIAL	DG15 DG16 DG16 DOOR RO: 40"W X 82"H DOOR HANDING: BOTH COLOR: WHITE HARDWARE: COMMERCIAL
e'-10"		5'-6"

MINISTRY OF PUBLIC WORKS



DEPARTMENT OF WORKS AND ENGINEERING

Government Administration Building, 3rd Floor | 56 Church Street | Hamilton, Bermuda HM12

Tel: (441) 501-3005




P.O. Box HM 428, Hamilton, Bermuda HM BX Tel: +1 441 707 0700 Email: info@brickverde.com Web: www.brickverde.com


GENERAL NOTES

- 1. DO NOT SCALE THE DRAWINGS
- 2. THE CONTRACTOR SHALL VERIFY ALL DIMENSIONS ON SITE AND REPORT ANY DISCREPANCIES TO THE OWNERS REPRESENTATIVE BEFORE PROCEEDING WITH THE WORKS.


DRAWING Prepared By: Date: KGW 15/05/2024 Checked By: Date: MM 15/05/2024 Approved By:				
No. Date: 1 Issued for Tender 09 Aug 2024 2 Issued for Tender 13 Aug 2024 2 Issuef for Tender 13 Aug 2024 2 Issuef for Tender 15 (Issuef for Tender 2 Issuef for Tender Issuef for Tender 3// Issuef for Tender Date: Issuef for Tender SGCALE: 3/8" = 1'-0" Date: Mercet SOURVEY Prepared By: Date: Mercet GOVERNMENT LAND SURVEY DEPT Date: Mercet Mercet DRAWING Prepared By: Date: Mercet Mercet	DA	AP 1 APPLIC		RAWINGS
1 Issued for Tender 09 Aug 2024 2 Issued for Tender 13 Aug 2024 2 Issued for Tender 15 Issued for Tender SURVEY Date: Date: SQUEVEY Date: Government Land SURVEY DEPT DESIGN Date: M Prepared By: Date: M KGW 15/05/2024 Date: DRAWING Date: M Prepared By: Date: M TC To Date: Project Number: Brick Verde Ref Number: 32/23/200	ISSL	JE / REVISION		
2 Issued for Tender 13 Aug 2024 2 Issued for Tender 13 Aug 2024 3 Aug 2024 13 Aug 2024 4 13 Aug 2024 13 Aug 2024 5 13 Aug 2024 13 Aug 2024 5 13 Aug 2024 13 Aug 2024 6 15 15 SCALE: 3/8" = 1'-0" 15 SURVEY Date: Date: GOVERNMENT LAND SURVEY DEPT Date: DESIGN Date: Prepared By: Date: KGW 15/05/2024 DRAWING Date: Prepared By: Date: KGW 15/05/2024 DRAWING Date: Prepared By: Date: KGW 15/05/2024 Approved By: TC Project Number: Brick Verde Ref Number: 32/23/200 240219AP Project Title: PROPOSED ASPHALT PLANT, AGGREGATE SCREENING PLANT, NEW WORKSHOP, LAB AND SITE SERVICES PUBLIC WORKS QUARRY & DEPOT PUBLIC WORKS QUARRY & DEPOT QUARRY ROAD <th>No.</th> <th></th> <th></th> <th>Date:</th>	No.			Date:
SCALE: 3/8" = 1'-0" SURVEY Prepared By: Date: GOVERNMENT LAND SURVEY DEPT DESIGN Prepared By: Date: KGW 15/05/2024 Checked By: Date: MM 15/05/2024 Project Number: Brick Verde Ref Number: 32/23/200 240219AP Project Title: PROPOSED ASPHALT PLANT, AGGREGATE SCREENING PLANT, NEW WORKSHOP, LAB AND SITE SERVICES PUBLIC WORKS QUARRY & DEPOT QUARRY ROAD HAMILTON PARISH BERMUDA Sheet Title: PROPOSED DOOR & WINDOW	1	Issued for Tende	er	09 Aug 2024
SURVEY Prepared By: Date: GOVERNMENT LAND SURVEY DEPT DESIGN Prepared By: Date: KGW 15/05/2024 Checked By: Date: MM 15/05/2024 DRAWING Prepared By: Date: KGW 15/05/2024 Checked By: Date: KGW 15/05/2024 Checked By: Date: MM 15/05/2024 Checked By: Date: KGW 15/05/2024 Project Mumber: Date: 15/05/2024 Project Number: Date: 15/05/2024 Project Title: PROPOSED ASPHALT PLANT, AGGREGATE SCREENING PLANT, NEW WORKSHOP, LAB AND SITE SERVICES PUBLIC WORKS QUARRY & DEPOT QUARRY ROAD HAMILTON PARISH BERMUDA	2	Issued for Tende	er	13 Aug 2024
SURVEY Prepared By: Date: GOVERNMENT LAND SURVEY DEPT DESIGN Prepared By: Date: KGW 15/05/2024 Checked By: Date: MM 15/05/2024 DRAWING Prepared By: Date: KGW 15/05/2024 Checked By: Date: KGW 15/05/2024 Checked By: Date: MM 15/05/2024 Checked By: Date: KGW 15/05/2024 Project Mumber: Date: 15/05/2024 Project Number: Date: 15/05/2024 Project Title: PROPOSED ASPHALT PLANT, AGGREGATE SCREENING PLANT, NEW WORKSHOP, LAB AND SITE SERVICES PUBLIC WORKS QUARRY & DEPOT QUARRY ROAD HAMILTON PARISH BERMUDA				
SURVEY Prepared By: Date: GOVERNMENT LAND SURVEY DEPT DESIGN Prepared By: Date: KGW 15/05/2024 Checked By: Date: MM 15/05/2024 DRAWING Prepared By: Date: KGW 15/05/2024 Checked By: Date: KGW 15/05/2024 Checked By: Date: MM 15/05/2024 Checked By: Date: KGW 15/05/2024 Project Mumber: Date: 15/05/2024 Project Number: Date: 15/05/2024 Project Title: PROPOSED ASPHALT PLANT, AGGREGATE SCREENING PLANT, NEW WORKSHOP, LAB AND SITE SERVICES PUBLIC WORKS QUARRY & DEPOT QUARRY ROAD HAMILTON PARISH BERMUDA				
SURVEY Prepared By: Date: GOVERNMENT LAND SURVEY DEPT DESIGN Prepared By: Date: KGW 15/05/2024 Checked By: Date: MM 15/05/2024 DRAWING Prepared By: Date: KGW 15/05/2024 Checked By: Date: KGW 15/05/2024 Checked By: Date: MM 15/05/2024 Checked By: Date: KGW 15/05/2024 Project Mumber: Date: 15/05/2024 Project Number: Date: 15/05/2024 Project Title: PROPOSED ASPHALT PLANT, AGGREGATE SCREENING PLANT, NEW WORKSHOP, LAB AND SITE SERVICES PUBLIC WORKS QUARRY & DEPOT QUARRY ROAD HAMILTON PARISH BERMUDA				
SURVEY Prepared By: Date: GOVERNMENT LAND SURVEY DEPT DESIGN Prepared By: Date: KGW 15/05/2024 Checked By: Date: MM 15/05/2024 DRAWING Prepared By: Date: KGW 15/05/2024 Checked By: Date: KGW 15/05/2024 Checked By: Date: MM 15/05/2024 Checked By: Date: KGW 15/05/2024 Project Mumber: Date: 15/05/2024 Project Number: Date: 15/05/2024 Project Title: PROPOSED ASPHALT PLANT, AGGREGATE SCREENING PLANT, NEW WORKSHOP, LAB AND SITE SERVICES PUBLIC WORKS QUARRY & DEPOT QUARRY ROAD HAMILTON PARISH BERMUDA				
SURVEY Prepared By: Date: GOVERNMENT LAND SURVEY DEPT DESIGN Prepared By: Date: KGW 15/05/2024 Checked By: Date: MM 15/05/2024 DRAWING Prepared By: Date: KGW 15/05/2024 Checked By: Date: KGW 15/05/2024 Checked By: Date: MM 15/05/2024 Checked By: Date: KGW 15/05/2024 Project Mumber: Date: 15/05/2024 Project Number: Date: 15/05/2024 Project Title: PROPOSED ASPHALT PLANT, AGGREGATE SCREENING PLANT, NEW WORKSHOP, LAB AND SITE SERVICES PUBLIC WORKS QUARRY & DEPOT QUARRY ROAD HAMILTON PARISH BERMUDA				
SURVEY Prepared By: Date: GOVERNMENT LAND SURVEY DEPT DESIGN Prepared By: Date: KGW 15/05/2024 Checked By: Date: MM 15/05/2024 DRAWING Prepared By: Date: KGW 15/05/2024 Checked By: Date: KGW 15/05/2024 Checked By: Date: MM 15/05/2024 Checked By: Date: KGW 15/05/2024 Project Mumber: Date: 15/05/2024 Project Number: Date: 15/05/2024 Project Title: PROPOSED ASPHALT PLANT, AGGREGATE SCREENING PLANT, NEW WORKSHOP, LAB AND SITE SERVICES PUBLIC WORKS QUARRY & DEPOT QUARRY ROAD HAMILTON PARISH BERMUDA				
SURVEY Prepared By: Date: GOVERNMENT LAND SURVEY DEPT DESIGN Prepared By: Date: KGW 15/05/2024 Checked By: Date: MM 15/05/2024 DRAWING Prepared By: Date: KGW 15/05/2024 Checked By: Date: KGW 15/05/2024 Checked By: Date: MM 15/05/2024 Checked By: Date: KGW 15/05/2024 Project Mumber: Date: 15/05/2024 Project Number: Date: 15/05/2024 Project Title: PROPOSED ASPHALT PLANT, AGGREGATE SCREENING PLANT, NEW WORKSHOP, LAB AND SITE SERVICES PUBLIC WORKS QUARRY & DEPOT QUARRY ROAD HAMILTON PARISH BERMUDA	SCA	LE: 3/8" = 1'-0"		
Prepared By: Date: GOVERNMENT LAND SURVEY DEPT DESIGN Prepared By: Date: KGW 15/05/2024 Checked By: Date: MM 15/05/2024 DRAWING Prepared By: Date: KGW 15/05/2024 Checked By: Date: KGW 15/05/2024 Checked By: Date: KGW 15/05/2024 Checked By: Date: MM 15/05/2024 Checked By: Date: KGW 15/05/2024 Checked By: Date: KGW 15/05/2024 Checked By: Date: KGW 240219AP Project Number: Brick Verde Ref Number: 32/23/200 240219AP Project Title: PROPOSED ASPHALT PLANT, AGGREGATE SCREENING PLANT PLANT PLANT, AGGREGATE SCREENING PLANT P				
GOVERNMENT LAND SURVEY DEPT DESIGN Prepared By: Date: KGW 15/05/2024 Checked By: Date: MM 15/05/2024 DRAWING Prepared By: Date: KGW 15/05/2024 Checked By: Date: KGW 15/05/2024 Checked By: Date: MM 15/05/2024 Checked By: Date: MINDOW Checked By: MINDOW C	SUR	VEY		
DESIGN Prepared By: Date: KGW 15/05/2024 Checked By: Date: MM 15/05/2024 DRAWING Prepared By: Date: KGW 15/05/2024 Checked By: Date: KGW 15/05/2024 Checked By: Date: MM 15/05/2024 Checked By: Date: Checked By: Date: Project Number: Brick Verde Ref Number: 32/23/200 240219AP Project Title: PROPOSED ASPHALT PLANT, AGGREGATE SCREENING PLANT, NEW WORKSHOP, LAB AND SITE SERVICES PUBLIC WORKS QUARRY & DEPOT QUARRY ROAD HAMILTON PARISH BERMUDA Sheet Title: PROPOSED DOOR & WINDOW	-	-		Date:
Prepared By: Date: 15/05/2024 Checked By: Date: 15/05/2024 DRAWING Prepared By: Date: KGW 15/05/2024 Checked By: Date: 15/05/2024 Checked By: Date: 15/05/2024 Checked By: Date: 15/05/2024 Approved By: TC Date: 15/05/2024 Project Number: Brick Verde Ref Number: 32/23/200 240219AP Project Title: PROPOSED ASPHALT PLANT, AGGREGATE SCREENING PLANT, NEW WORKSHOP, LAB AND SITE SERVICES PUBLIC WORKS QUARRY & DEPOT QUARRY ROAD HAMILTON PARISH BERMUDA Sheet Title: PROPOSED DOOR & WINDOW				
KGW 15/05/2024 Checked By: Date: MM 15/05/2024 DRAWING Prepared By: Date: KGW 15/05/2024 Checked By: Date: MM 15/05/2024 Checked By: Date: KGW 15/05/2024 Checked By: Date: MM 15/05/2024 Checked By: Date: MM 2024 Checked By: Date: Stresser Stresser S	DES	IGN		
Checked By: Date: MM 15/05/2024 DRAWING Prepared By: Date: KGW 15/05/2024 Checked By: Date: MM 15/05/2024 Checked By: Date: MM 15/05/2024 Approved By: TC Project Number: Brick Verde Ref Number: 32/23/200 240219AP Project Title: PROPOSED ASPHALT PLANT, AGGREGATE SCREENING PLANT, AGGREGATE SCREENING PLANT, NEW WORKSHOP, LAB AND SITE SERVICES PUBLIC WORKS QUARRY & DEPOT QUARRY ROAD HAMILTON PARISH BERMUDA Sheet Title: PROPOSED DOOR & WINDOW		•		
MM 15/05/2024 DRAWING Prepared By: Date: KGW 15/05/2024 Checked By: Date: MM 15/05/2024 Approved By: TC Project Number: Brick Verde Ref Number: 32/23/200 240219AP Project Title: PROPOSED ASPHALT PLANT, AGGREGATE SCREENING PLANT, NEW WORKSHOP, LAB AND SITE SERVICES PUBLIC WORKS QUARRY & DEPOT QUARRY ROAD HAMILTON PARISH BERMUDA Sheet Title: PROPOSED DOOR & WINDOW				_
Prepared By: KGW 15/05/2024 Checked By: Date: MM 15/05/2024 Approved By: TC Project Number: Brick Verde Ref Number: 32/23/200 240219AP Project Title: PROPOSED ASPHALT PLANT, AGGREGATE SCREENING PLANT, NEW WORKSHOP, LAB AND SITE SERVICES PUBLIC WORKS QUARRY & DEPOT QUARRY ROAD HAMILTON PARISH BERMUDA Sheet Title: PROPOSED DOOR & WINDOW	MM	lica Dy:		
KGW 15/05/2024 Checked By: MM Date: 15/05/2024 Approved By: TC Project Number: Brick Verde Ref Number: 32/23/200 240219AP Project Title: PROPOSED ASPHALT PLANT, AGGREGATE SCREENING PLANT, NEW WORKSHOP, LAB AND SITE SERVICES PUBLIC WORKS QUARRY & DEPOT QUARRY ROAD HAMILTON PARISH BERMUDA Sheet Title: PROPOSED DOOR & WINDOW	DRA	WING		
Checked By: MM Date: 15/05/2024 Approved By: TC Project Number: Brick Verde Ref Number: 32/23/200 240219AP Project Title: PROPOSED ASPHALT PLANT, AGGREGATE SCREENING PLANT, NEW WORKSHOP, LAB AND SITE SERVICES PUBLIC WORKS QUARRY & DEPOT QUARRY ROAD HAMILTON PARISH BERMUDA Sheet Title: PROPOSED DOOR & WINDOW	-	•		
MM 15/05/2024 Approved By: TC Project Number: Brick Verde Ref Number: 32/23/200 240219AP Project Title: PROPOSED ASPHALT PLANT, AGGREGATE SCREENING PLANT, NEW WORKSHOP, LAB AND SITE SERVICES PUBLIC WORKS QUARRY & DEPOT QUARRY ROAD HAMILTON PARISH BERMUDA Sheet Title: PROPOSED DOOR & WINDOW				
TC Project Number: Brick Verde Ref Number: 32/23/200 240219AP Project Title: PROPOSED ASPHALT PLANT, AGGREGATE SCREENING PLANT, NEW WORKSHOP, LAB AND SITE SERVICES PUBLIC WORKS QUARRY & DEPOT QUARRY ROAD HAMILTON PARISH BERMUDA Sheet Title: PROPOSED DOOR & WINDOW	MM			15/05/2024
Project Number: Brick Verde Ref Number: 32/23/200 240219AP Project Title: PROPOSED ASPHALT PLANT, AGGREGATE SCREENING PLANT, NEW WORKSHOP, LAB AND SITE SERVICES PUBLIC WORKS QUARRY & DEPOT QUARRY ROAD HAMILTON PARISH BERMUDA Sheet Title: PROPOSED DOOR & WINDOW	Appr	oved By:		
240219AP Project Title: PROPOSED ASPHALT PLANT, AGGREGATE SCREENING PLANT, NEW WORKSHOP, LAB AND SITE SERVICES PUBLIC WORKS QUARRY & DEPOT QUARRY ROAD HAMILTON PARISH BERMUDA Sheet Title: PROPOSED DOOR & WINDOW	тС			
240219AP Project Title: PROPOSED ASPHALT PLANT, AGGREGATE SCREENING PLANT, NEW WORKSHOP, LAB AND SITE SERVICES PUBLIC WORKS QUARRY & DEPOT QUARRY ROAD HAMILTON PARISH BERMUDA Sheet Title: PROPOSED DOOR & WINDOW	Proje	ect Number:	Brick Verde	e Ref Number:
Project Title: PROPOSED ASPHALT PLANT, AGGREGATE SCREENING PLANT, NEW WORKSHOP, LAB AND SITE SERVICES PUBLIC WORKS QUARRY & DEPOT QUARRY ROAD HAMILTON PARISH BERMUDA Sheet Title: PROPOSED DOOR & WINDOW				
PROPOSED ASPHALT PLANT, AGGREGATE SCREENING PLANT, NEW WORKSHOP, LAB AND SITE SERVICES PUBLIC WORKS QUARRY & DEPOT QUARRY ROAD HAMILTON PARISH BERMUDA Sheet Title: PROPOSED DOOR & WINDOW				210210/4
AGGREGATE SCREENING PLANT, NEW WORKSHOP, LAB AND SITE SERVICES PUBLIC WORKS QUARRY & DEPOT QUARRY ROAD HAMILTON PARISH BERMUDA Sheet Title: PROPOSED DOOR & WINDOW	-			· · · -
NEW WORKSHOP, LAB AND SITE SERVICES PUBLIC WORKS QUARRY & DEPOT QUARRY ROAD HAMILTON PARISH BERMUDA Sheet Title: PROPOSED DOOR & WINDOW				•
SERVICES PUBLIC WORKS QUARRY & DEPOT QUARRY ROAD HAMILTON PARISH BERMUDA Sheet Title: PROPOSED DOOR & WINDOW				•
PUBLIC WORKS QUARRY & DEPOT QUARRY ROAD HAMILTON PARISH BERMUDA Sheet Title: PROPOSED DOOR & WINDOW			F, LAD AN	
QUARRY ROAD HAMILTON PARISH BERMUDA Sheet Title: PROPOSED DOOR & WINDOW	_		RRY & DEPOT	
BERMUDA Sheet Title: PROPOSED DOOR & WINDOW				
Sheet Title: PROPOSED DOOR & WINDOW				
PROPOSED DOOR & WINDOW	BER	MUDA		
				_
SCHEDULES			OR & WIND	WOW
	SC	HEDULES		

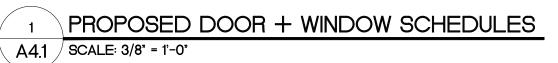

Revisions:	Sheet Number:	
\wedge		
		A4.1
/ Z \		

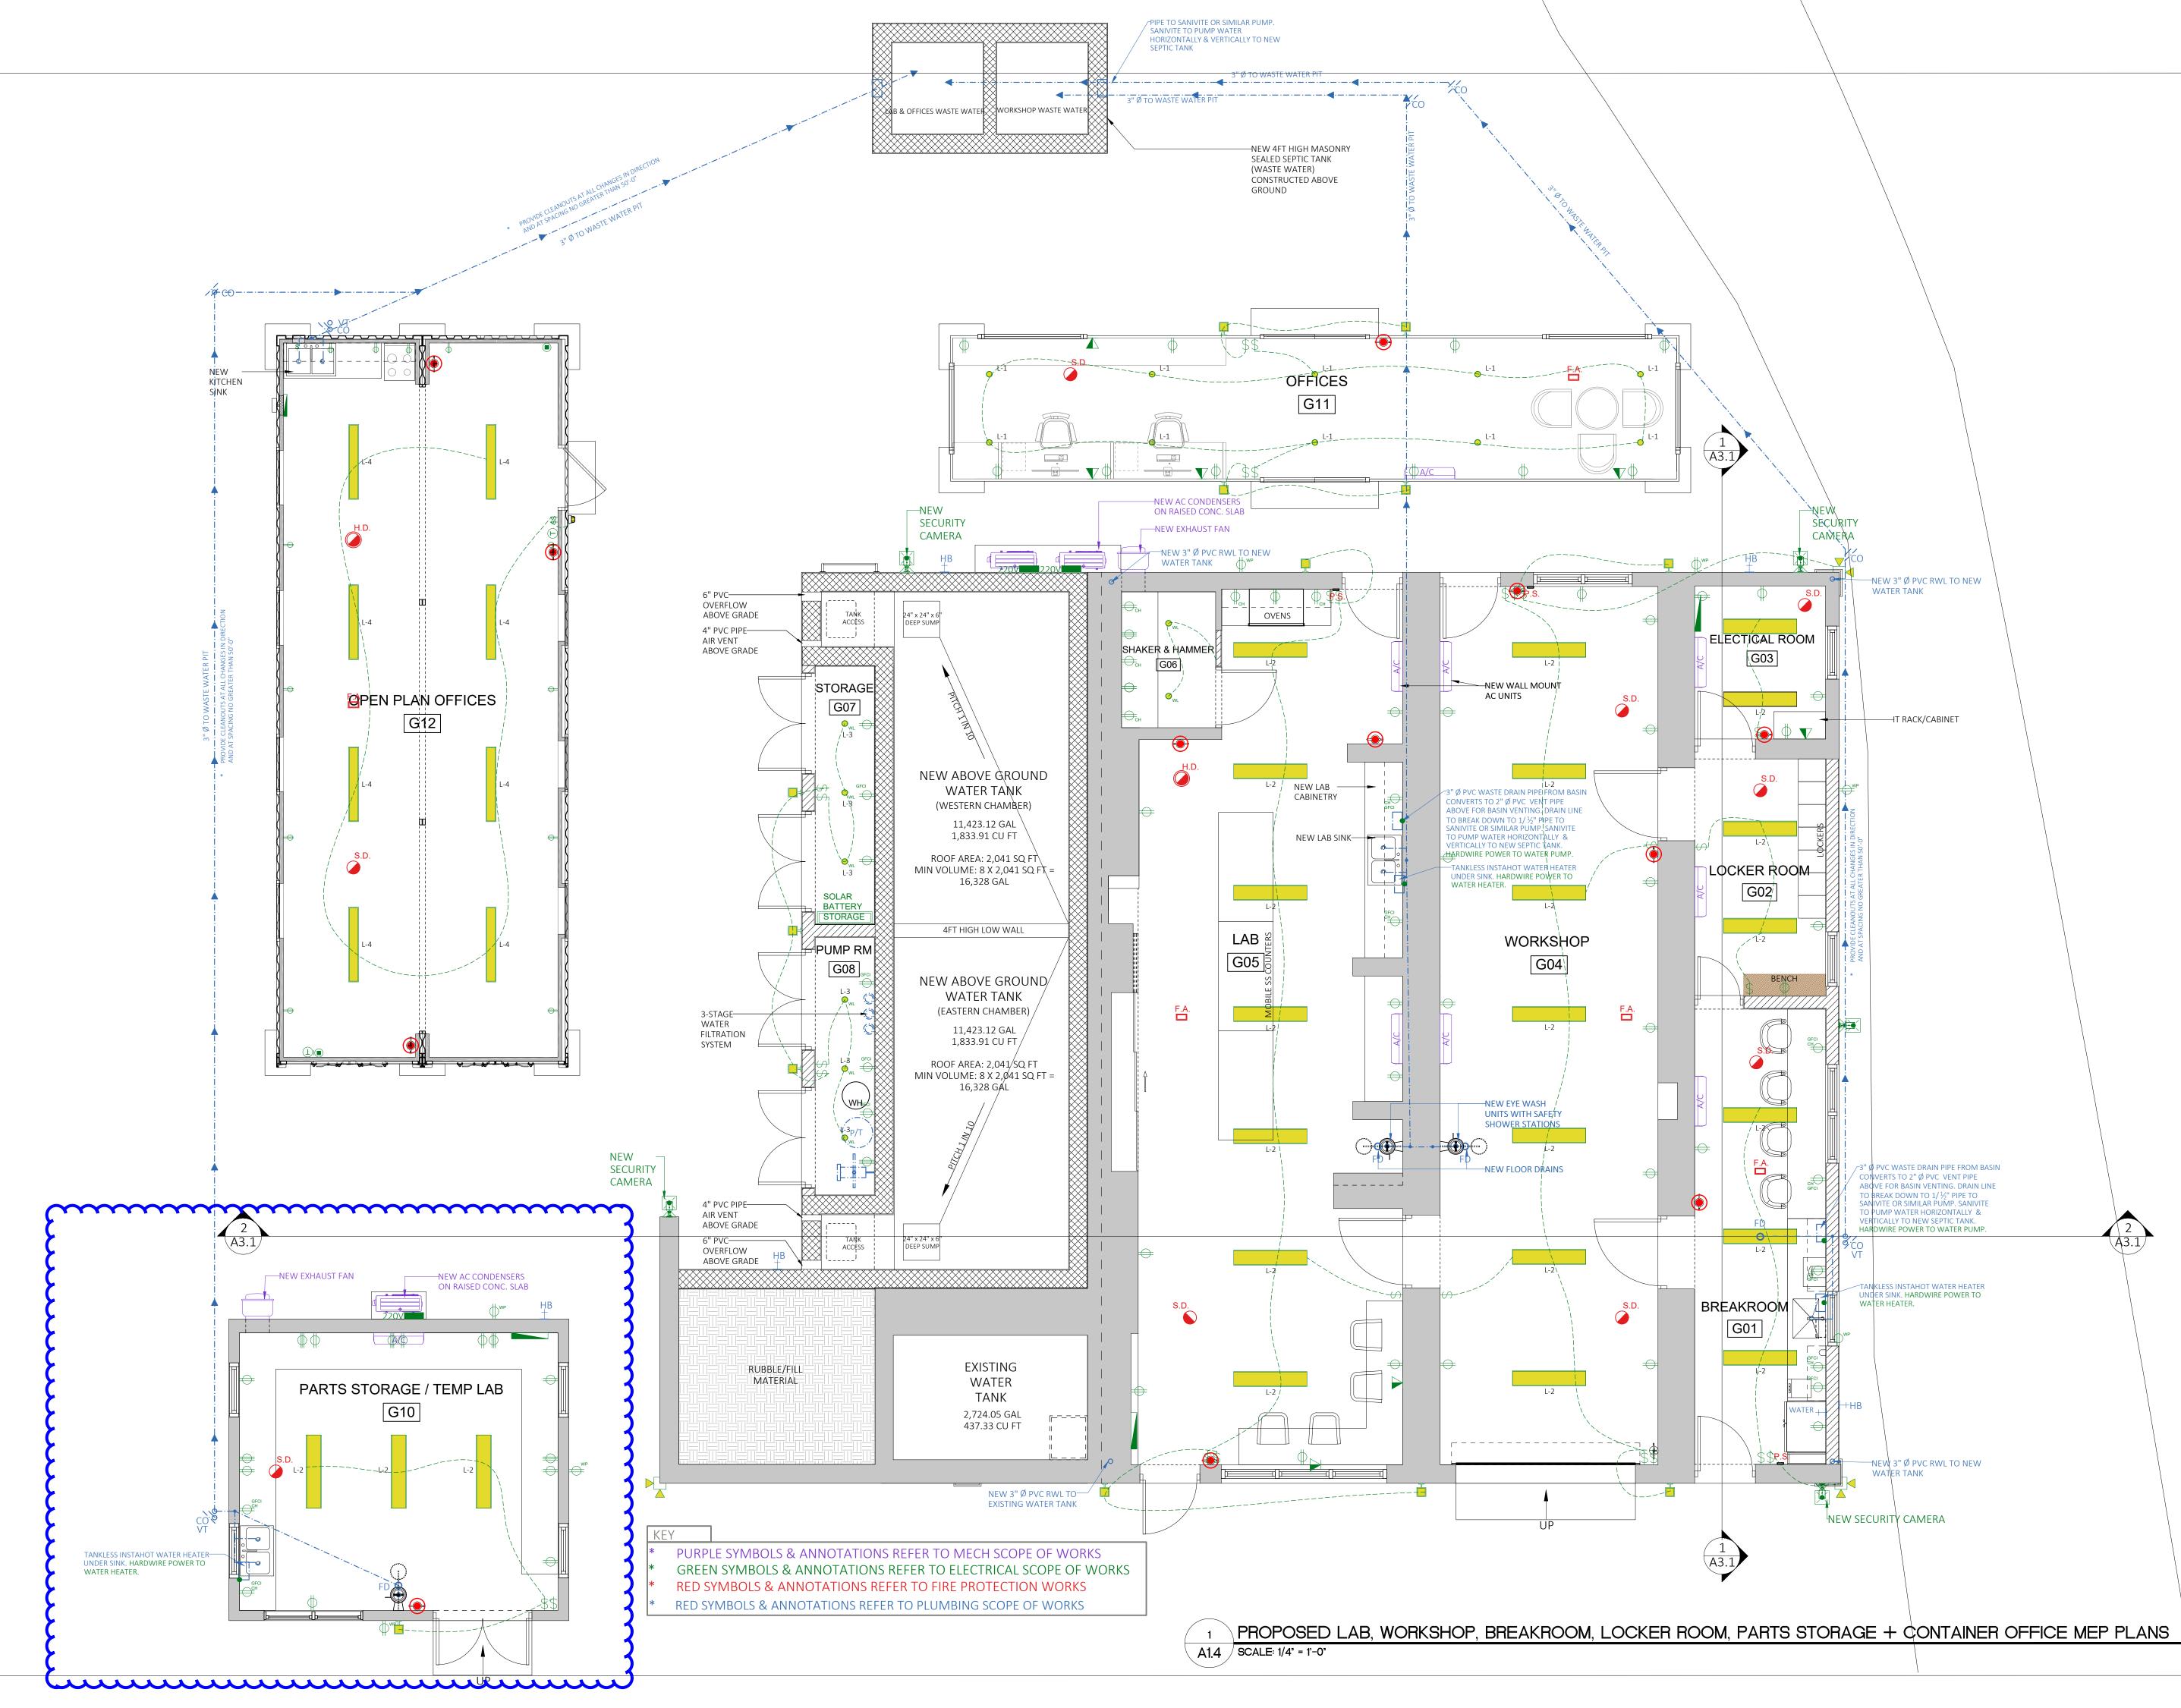

DEPARTMENT OF WO AND ENGINEERING	
Government Administration Bu 3rd Floor 56 Church Street Hamilton, Tel: (441) 501-3005	
P.O. Box HM 428, Hamilton, Bermud Tel: +1 441 707 0700 Email: info@brickverde.com Web: www.brickverde.com	e vices a HM BX
GENERAL NOTES 1. DO NOT SCALE THE DRAWINGS	
2. THE CONTRACTOR SHALL VERI DIMENSIONS ON SITE AND REP DISCREPANCIES TO THE OWNE REPRESENTATIVE BEFORE PRO WITH THE WORKS.	ORT ANY RS
DAP 1 APPLICATION DF	RAWING
ISSUE / REVISION	
No. 1 Issued for DAP 1 Submission	Date: 22 Jul 2024
2 Issued for DAP 1 Submission	26 Jul 2024
<u>SCALE:</u> 1/4" = 1'-0"	
SURVEY	
Prepared By: GOVERNMENT LAND SURVEY DEPT	Date:
<u>DESIGN</u> Prepared By:	Date:
KGW Checked By:	15/05/2024 Date:
MM	15/05/2024
DRAWING Prepared By:	Date:
	15/05/2024 Date:
KGW	
Prepared By: KGW Checked By: MM	15/05/2024
KGW Checked By: MM Approved By:	15/05/2024
KGW Checked By: MM Approved By: TC	15/05/2024 Ref Number:
KGW Checked By: MM Approved By: TC	

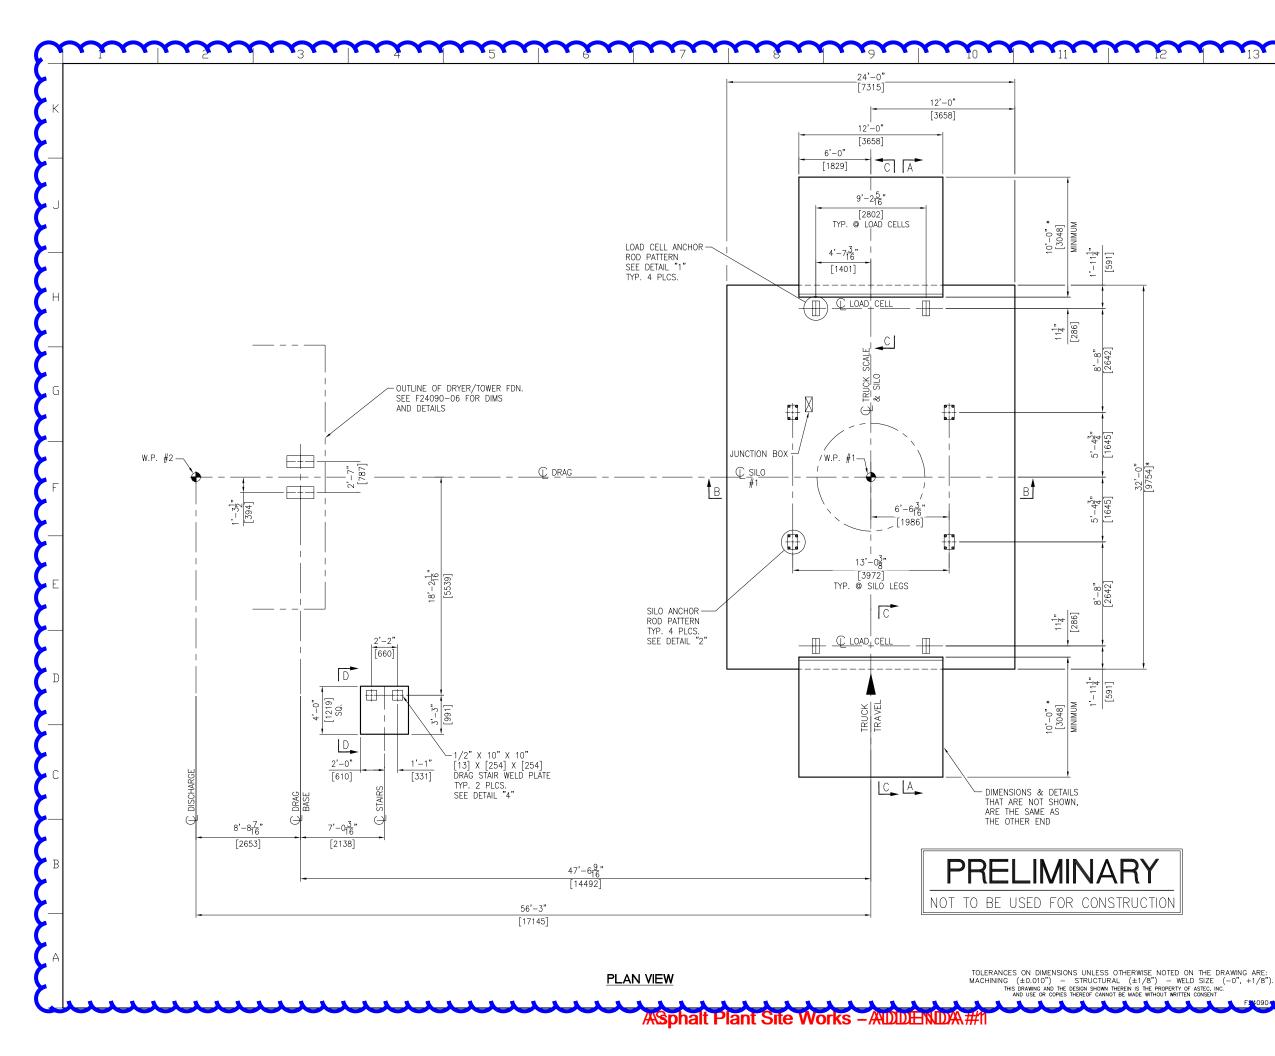


 NOTES: 1. FOUNDATIONS SHOWN HEREIN ARE DESIGNED FOR A MINIMUM SOIL BEARING PRESSURE OF 3,500 PSF. THE CUSTOMER IS RESPONSIBLE TO ENSURE THAT THE ALLOWABLE SOIL BEARING PRESSURE AT THE SITE EQUALS OR EXCEEDS THE DESIGN VALUE. 2. CONCRETE: F'C = 4,000 P.S.I. @ 28 DAYS UNLESS NOTED OTHERWISE 3. REINF. STEEL: ASTM-A615, GRADE 60 4. EMBEDDED BOLTS, EMBEDDED PLATES, HEX NUTS AND ANCHOR RODS FURNISHED BY CUSTOMER. BOLTS/RODS ARE TO BE A MINIMUM 58,000 PSI TENSILE STRENGTH. NELSON STUDS ARE NOT PERMITTED TO BE USED. 5. BENCHMARK ELEVATION 10'-0" [3048] TO BE ESTABLISHED @ TOP OF FINISHED EORCRETE NEAR SILO FOUNDATION. 6. A FLATNESS TOLERANCE OF ±1/8" [3] OVER 10'-0" [3048] IS TO BE MAINTAINED FOR ALL CONCRETE SLAB SURFACES 7. PROVIDE 12" [305] MIN. OF A WELL DRAINING GRANULAR BASE BELOW CONCRETE FOOTING. 8. WORK THIS DRAWING WITH DWGS. F24-090-02. 9. CONTRACTOR MAY USE #4 REBAR @ ~ 12" [305] CTRS. EACH WAY IN LIEU OF 4 X 4-W6 X W6 WWF. 10.FOR PLANT LAYOUT SEE DWG. D24-090-1A. 11. PLACE SUFFICIENT EXPANSION JOINT MATERIAL BETWEEN FOOTINGS. 12. THE OWNER IS RESPONSIBLE FOR GRADING THE SURROUNDING 	14 15 16	\mathbf{D}
 SOIL BEARING PRESSURE OF 3,500 PSF. THE CUSTOMER IS RESPONSIBLE TO ENSURE THAT THE ALLOWABLE SOIL BEARING PRESSURE AT THE SITE EQUALS OR EXCEEDS THE DESIGN VALUE. CONCRETE: F'C = 4,000 P.S.I. @ 28 DAYS UNLESS NOTED OTHERWISE REINF. STEEL: ASTM-A615, GRADE 60 EMBEDDED BOLTS, EMBEDDED PLATES, HEX NUTS AND ANCHOR RODS FURNISHED BY CUSTOMER. BOLTS/RODS ARE TO BE A MINIMUM 58,000 PSI TENSILE STRENGTH. NELSON STUDS ARE NOT PERMITTED TO BE USED. BENCHMARK ELEVATION 10'-0" [3048] TO BE ESTABLISHED @ TOP OF FINISHED CONCRETE NEAR SILO FOUNDATION. A FLATNESS TOLERANCE OF ±1/8" [3] OVER 10'-0" [3048] IS TO BE MAINTAINED FOR ALL CONCRETE SLAB SURFACES PROVIDE 12" [305] MIN. OF A WELL DRAINING GRANULAR BASE BELOW CONCRETE FOOTING. WORK THIS DRAWING WITH DWGS. F24-090-02. CONTRACTOR MAY USE #4 REBAR @ ~ 12" [305] CTRS. EACH WAY IN LIEU OF 4 X 4-W6 X W6 WWF. FOR PLANT LAYOUT SEE DWG. D24-090-1A. PACONINGS. 	NOTES:	D
 OTHERWISE 3. REINF, STEEL: ASTM-A615, GRADE 60 4. EMBEDDED BOLTS, EMBEDDED PLATES, HEX NUTS AND ANCHOR RODS FURNISHED BY CUSTOMER. BOLTS/RODS ARE TO BE A MINIMUM 58,000 PSI TENSILE STRENGTH. NELSON STUDS ARE NOT PERMITTED TO BE USED. 5. BENCHMARK ELEVATION 10'-0" [3048] TO BE ESTABLISHED @ TOP OF FINISHED CONCRETE NEAR SILO FOUNDATION. 6. A FLATNESS TOLERANCE OF ±1/8" [3] OVER 10'-0" [3048] IS TO BE MAINTAINED FOR ALL CONCRETE SLAB SURFACES 7. PROVIDE 12" [305] MIN. OF A WELL DRAINING GRANULAR BASE BELOW CONCRETE FOOTING. 8. WORK THIS DRAWING WITH DWGS. F24-090-02. 9. CONTRACTOR MAY USE #4 REBAR @ ~ 12" [305] CTRS. EACH WAY IN LIEU OF 4 X 4-W6 X W6 WWF. 10.FOR PLANT LAYOUT SEE DWG. D24-090-1A. 11. PLACE SUFFICIENT EXPANSION JOINT MATERIAL BETWEEN FOOTINGS. 	SOIL BEARING PRESSURE OF 3,500 PSF. THE CUSTOMER IS RESPONSIBLE TO ENSURE THAT THE ALLOWABLE SOIL BEARING PRESSURE AT THE SITE EQUALS OR EXCEEDS THE DESIGN	
 REINF. STEEL: ASTM-A615, GRADE 60 EMBEDDED BOLTS, EMBEDDED PLATES, HEX NUTS AND ANCHOR RODS FURNISHED BY CUSTOMER. BOLTS/RODS ARE TO BE A MINIMUM 58,000 PSI TENSILE STRENGTH. NELSON STUDS ARE NOT PERMITTED TO BE USED. BENCHMARK LLEVATION 10'-0" [3048] TO BE ESTABLISHED @ TOP OF FINISHED CONCRETE NEAR SILO FOUNDATION. A FLATNESS TOLERANCE OF ±1/8" [3] OVER 10'-0" [3048] IS TO BE MAINTAINED FOR ALL CONCRETE SLAB SURFACES PROVIDE 12" [305] MIN. OF A WELL DRAINING GRANULAR BASE BELOW CONCRETE FOOTING. WORK THIS DRAWING WITH DWGS. F24-090-02. CONTRACTOR MAY USE #4 REBAR @ ~ 12" [305] CTRS. EACH WAY IN LIEU OF 4 X 4-W6 X W6 WWF. FOR PLANT LAYOUT SEE DWG. D24-090-1A. PLACE SUFFICIENT EXPANSION JOINT MATERIAL BETWEEN FOOTINGS. 		X
 RODS FURNISHED BY CUSTOMER. BOLTS/RODS ARE TO BE A MINIMUM 58,000 PSI TENSILE STRENGTH. NELSON STUDS ARE NOT PERMITTED TO BE USED. 5. BENCHMARK ELEVATION 10'-0" [3048] TO BE ESTABLISHED @ TOP OF FINISHED CONCRETE NEAR SILO FOUNDATION. 6. A FLATNESS TOLERANCE OF ±1/8" [3] OVER 10'-0" [3048] IS TO BE MAINTAINED FOR ALL CONCRETE SLAB SURFACES 7. PROVIDE 12" [305] MIN. OF A WELL DRAINING GRANULAR BASE BELOW CONCRETE FOOTING. 8. WORK THIS DRAWING WITH DWGS. F24-090-02. 9. CONTRACTOR MAY USE #4 REBAR @ ~ 12" [305] CTRS. EACH WAY IN LIEU OF 4 X 4-W6 X W6 WWF. 10. FOR PLANT LAYOUT SEE DWG. D24-090-1A. 11. PLACE SUFFICIENT EXPANSION JOINT MATERIAL BETWEEN FOOTINGS. 	3. REINF. STEEL: ASTM-A615, GRADE 60	
 TOP OF FINISHED CONCRETE NEÂR SILO FOUNDATION. 6. A FLATNESS TOLERANCE OF ±1/8" [3] OVER 10'-0" [3048] IS TO BE MAINTAINED FOR ALL CONCRETE SLAB SURFACES 7. PROVIDE 12" [305] MIN. OF A WELL DRAINING GRANULAR BASE BELOW CONCRETE FOOTING. 8. WORK THIS DRAWING WITH DWGS. F24-090-02. 9. CONTRACTOR MAY USE #4 REBAR @ ~ 12" [305] CTRS. EACH WAY IN LIEU OF 4 X 4-W6 X W6 WWF. 10.FOR PLANT LAYOUT SEE DWG. D24-090-1A. 11. PLACE SUFFICIENT EXPANSION JOINT MATERIAL BETWEEN FOOTINGS. 	RODS FURNISHED BY CUSTOMER. BOLTS/RODS ARE TO BE A MINIMUM 58,000 PSI TENSILE STRENGTH. NELSON STUDS ARE	R
 TO BE MAINTAINED FOR ALL CONCRÈTÉ SLAB SURFACÈS 7. PROVIDE 12" [305] MIN. OF A WELL DRAINING GRANULAR BASE BELOW CONCRETE FOOTING. 8. WORK THIS DRAWING WITH DWGS. F24-090-02. 9. CONTRACTOR MAY USE #4 REBAR @ ~ 12" [305] CTRS. EACH WAY IN LIEU OF 4 X 4-W6 X W6 WWF. 10.FOR PLANT LAYOUT SEE DWG. D24-090-1A. 11. PLACE SUFFICIENT EXPANSION JOINT MATERIAL BETWEEN FOOTINGS. 		Ŋ
 BELOW CONCRETE FOOTING. 8. WORK THIS DRAWING WITH DWGS. F24-090-02. 9. CONTRACTOR MAY USE #4 REBAR @ ~ 12" [305] CTRS. EACH WAY IN LIEU OF 4 X 4-W6 X W6 WWF. 10.FOR PLANT LAYOUT SEE DWG. D24-090-1A. 11. PLACE SUFFICIENT EXPANSION JOINT MATERIAL BETWEEN FOOTINGS. 		Ŋ
 9. CONTRACTOR MAY USE #4 REBAR @ ~ 12" [305] CTRS. EACH WAY IN LIEU OF 4 X 4-W6 X W6 WWF. 10.FOR PLANT LAYOUT SEE DWG. D24-090-1A. 11. PLACE SUFFICIENT EXPANSION JOINT MATERIAL BETWEEN FOOTINGS. 		1
WAY IN LIEU OF 4 X 4-W6 X W6 WWF. 10.FOR PLANT LAYOUT SEE DWG. D24-090-1A. 11. PLACE SUFFICIENT EXPANSION JOINT MATERIAL BETWEEN FOOTINGS.		K
11. PLACE SUFFICIENT EXPANSION JOINT MATERIAL BETWEEN FOOTINGS.		K
12. THE OWNER IS RESPONSIBLE FOR GRADING THE SURROUNDING	11. PLACE SUFFICIENT EXPANSION JOINT MATERIAL BETWEEN	K
AREA (DETERMINED BY LOCAL TOPOGRAPHY) TO PROVIDE FOR DRAINAGE AWAY FROM EQUIPMENT.	AREA (DETERMINED BY LOCAL TOPOGRAPHY) TO PROVIDE FOR	5
13.FOUNDATION DRAWINGS SHOWN HEREIN HAVE BEEN DESIGNED FOR THE HAMILTON, BERMUDA SITE (W.O. 24–090) AND SHALL BE VOIDED FOR USE AT ANY OTHER SITE.	13.FOUNDATION DRAWINGS SHOWN HEREIN HAVE BEEN DESIGNED FOR THE HAMILTON, BERMUDA SITE (W.O. 24–090) AND SHALL	R


14.DO NOT SCALE. THIS DRAWING MAY BE A REDUCED COPY.

	REBAR CONVER	SION CHART
	IMPERIAL BAR DIA.	METRIC BAR DIA
#4	.500	12.7
#6	.75	19
#8	1"	25.4
#9	1.125"	28.5

* CUSTOMER MUST ENSURE TRUCK APPROACH LENGTH COMPLIES WITH STATE AND LOCAL REGULATIONS



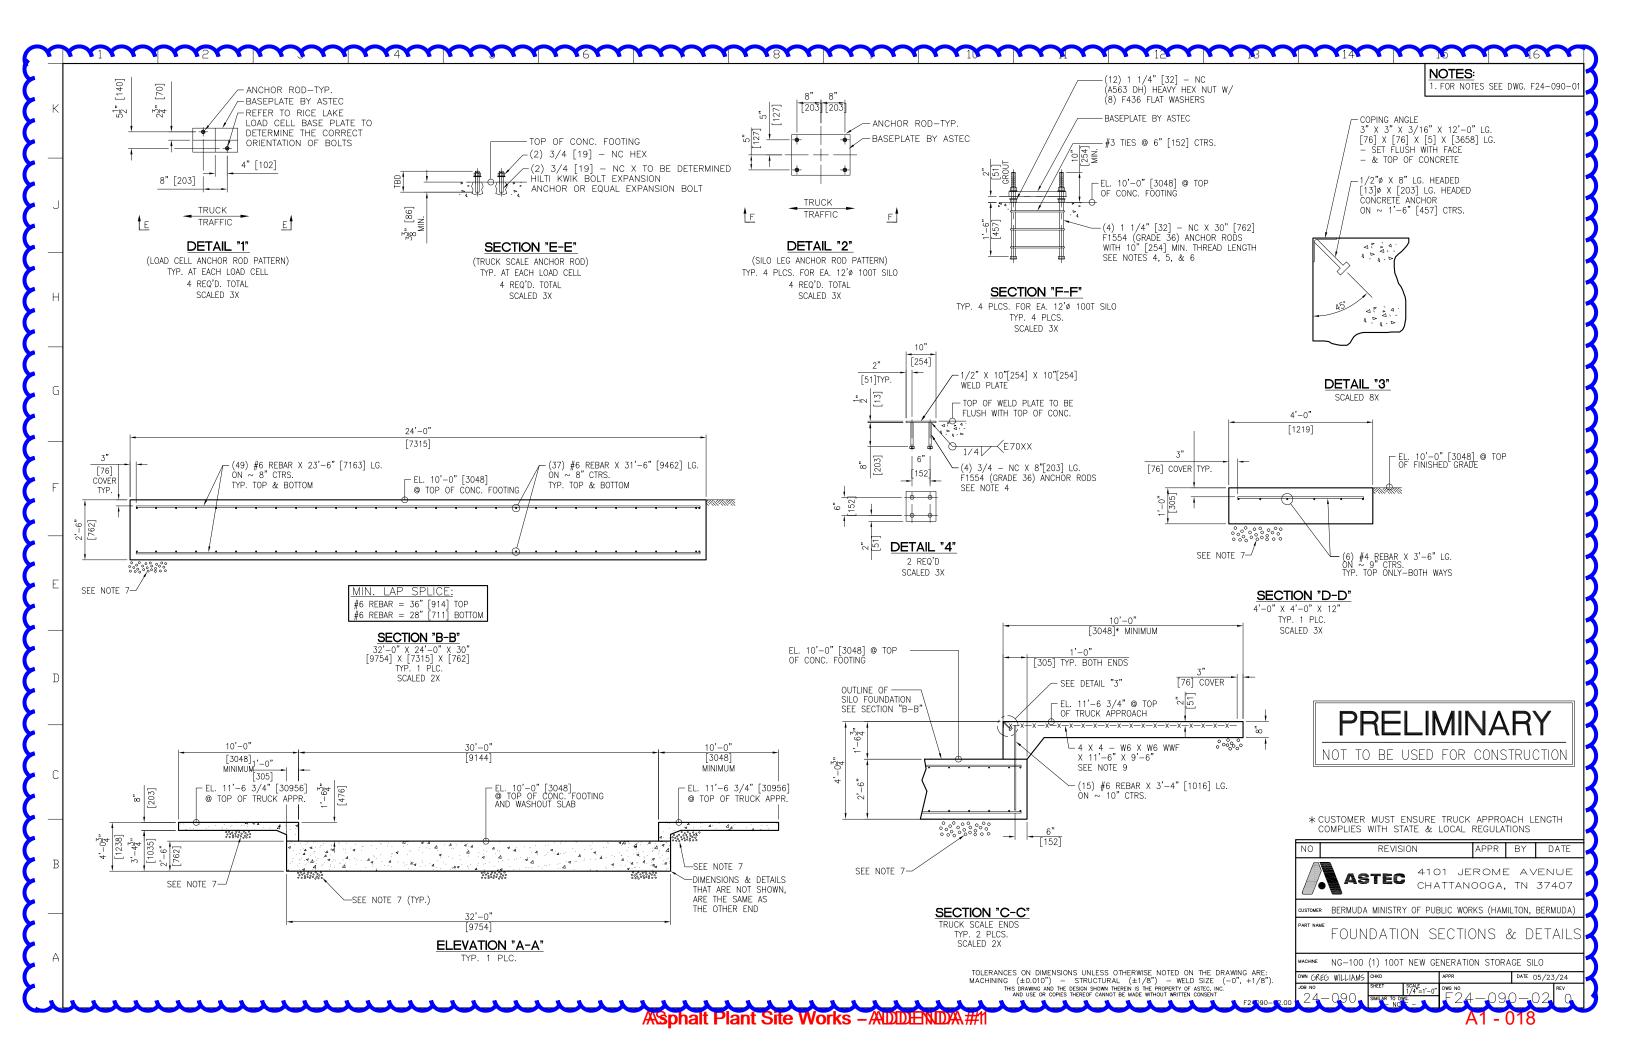


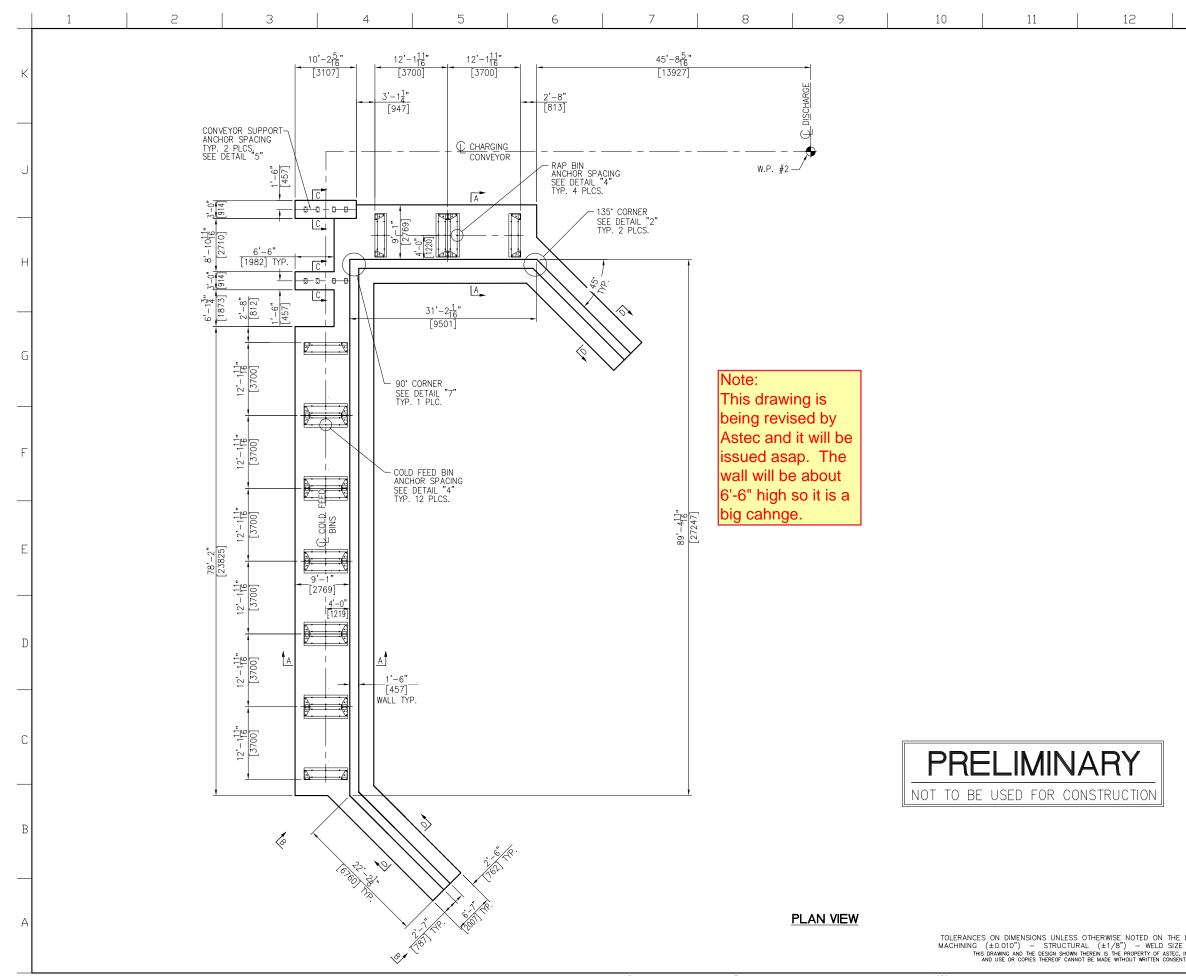



NOTES:	
 FOUNDATIONS SHOWN HEREIN ARE DESIGNED FOR A MINIMUM SOIL BEARING PRESSURE OF 2,000 PSF. THE CUSTOMER IS RESPONSIBLE TO ENSURE THAT THE ALLOWABLE SOIL BEARIN PRESSURE AT THE SITE EQUALS OR EXCEEDS THE DESIGN VALUE. 	IG
2. CONCRETE: F'C = 4,000 P.S.I. @ 28 DAYS UNLESS NOTED OTHERWISE	
 REINF. STEEL: ASTM-A615, GRADE 60 EMBEDDED BOLTS, EMBEDDED PLATES, HEX NUTS AND ANCH RODS FURNISHED BY CUSTOMER. BOLTS/RODS ARE TO BE A MINIMUM 58,000 PSI TENSILE STRENGTH. NELSON STUDS ARE NOT PERMITTED TO BE USED. 	
 5. 5. BENCHMARK ELEVATION 100'-0"[30480] TO BE ESTABLISH	ED N.
6. A FLATNESS TOLERANCE OF ±1/8" [3] OVER 10'-0" [3048] TO BE MAINTAINED FOR ALL CONCRETE SLAB SURFACES	IS
 PROVIDE 12" [305] MIN. OF A WELL DRAINING GRANULAR BA BELOW CONCRETE FOOTING. 	SE
 WORK THIS DRAWING WITH DWGS. F24-090-04 & 05. POUR CONCRETE RETAINING WALL AFTER CONCRETE FOOTING HAS HARDENED 	
10. REBAR LENGTHS MAY VARY DUE TO ANGLES AND OR NOTCH OUT AREAS IN THE CONC. FOOTING, CUT REBAR AS NEEDED.	ED
 PROVIDE CONTROL JOINTS @ ~ 10' SPACINGS. DO NOT PLACE RETAINING WALL WEEP HOLES NEAR OR AROI EQUIPMENT LEGS. EQUIPMENT LEGS OR ANY OTHER OBJECTS LOCATED IN THE RUNOFF PATH MAY CAUSE GRAVEL BUILD L AND OR DRAIN CLOGGING. 	
13. THE OWNER IS RESPONSIBLE FOR GRADING THE SURROUNDIN AREA (DETERMINED BY LOCAL TOPOGRAPHY) TO PROVIDE FO	
DRAINAGE AWAY FROM EQUIPMENT. 14 FOUNDATION DRAWINGS SHOWN HEREIN HAVE BEEN DESIGNED FOR THE HAMILTON, BERMUDA SITE (W.O. 24–090) AND SHA BE VOIDED FOR USE AT ANY OTHER SITE. 15 DO NOT SCALE. THIS DRAWING MAY BE A REDUCED COPY.	
IJ.DU NUT JUALE. INIS DRAWING MAT DE A REDUCED COPT.	

	REBAR CONVER	SION CHART
	IMPERIAL BAR DIA.	METRIC BAR DIA
#4	.500	12.7
#6	.75	19
#8	1"	25.4
# 9	1.125"	28.5


	NO		REVIS	ION		APPR	ΒY	D,	ATE
		AS	TEC)1 JE				
	CUSTOMER	BERMUDA	MINISTR	Y OF PUE	BLIC WOR	KS (HAM	IILTON,	HM 1	2)
	PART NAME	FOUN	IDATI	on f	PLAN				
	MACHINE	(6) COL	D FEED	BINS &	(2) RA	AP BINS	ò		
DRAWING ARE: E (-0", +1/8").	DWN GREC	G WILLIAMS	СНКД		APPR		DATE (06/04	/24
INC. NT F24090-03.00	јов № 24-	-090	SHEET SIMILAR TO DV — NON		^{рwg no} F24	-09	0-0)3	
					A	1 - 1	019		

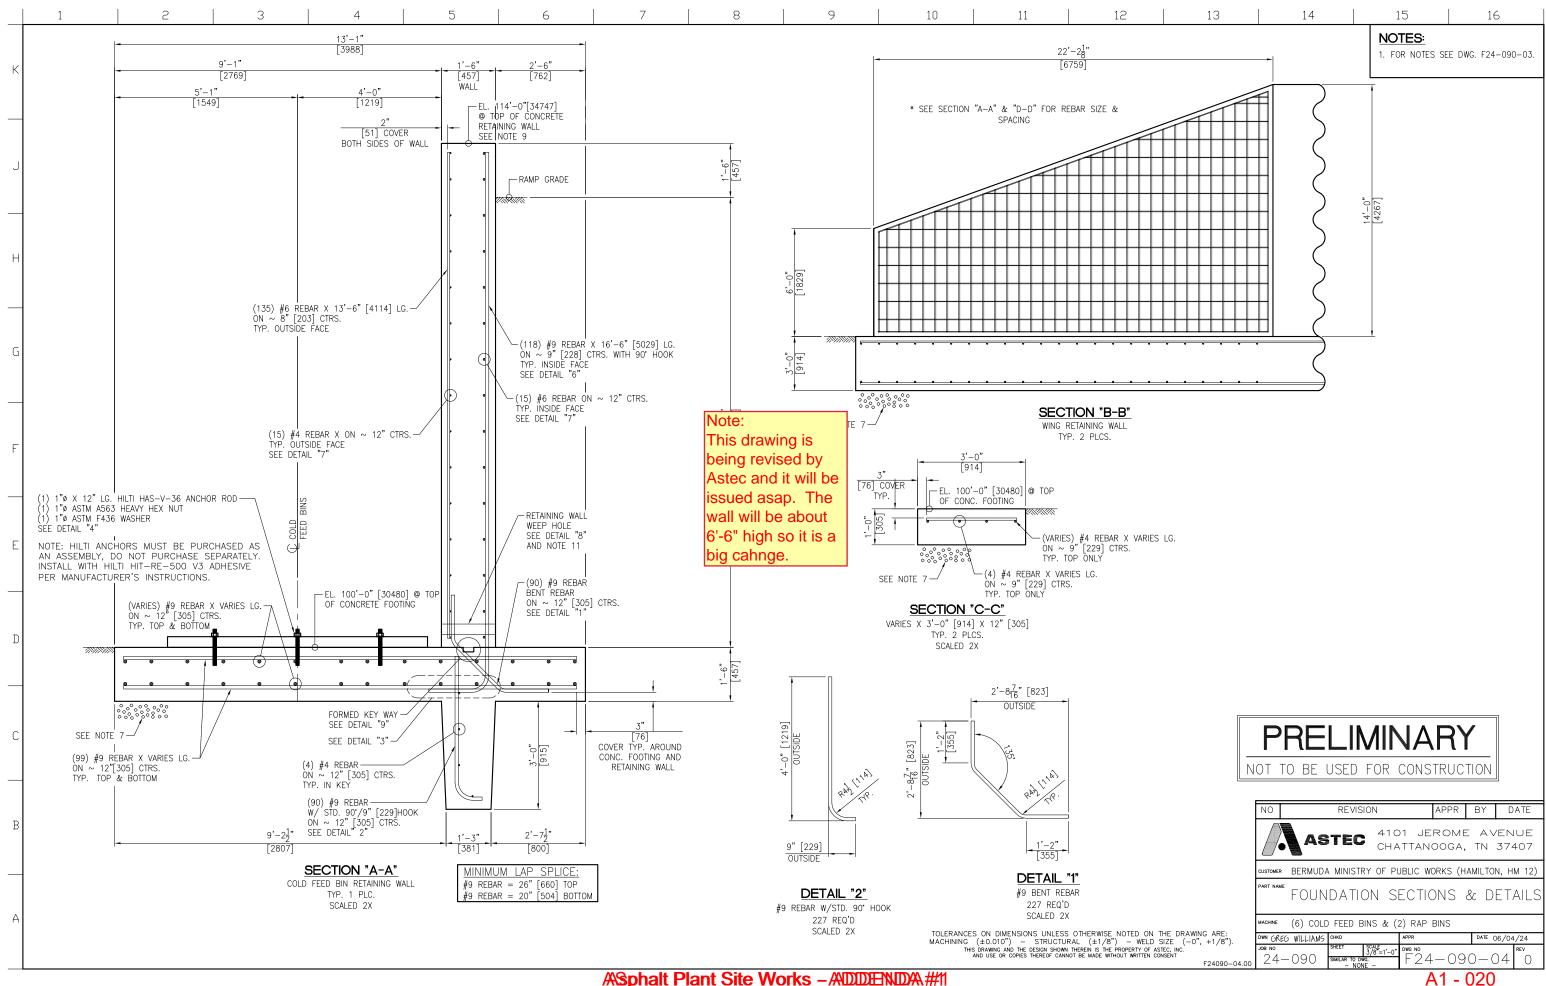


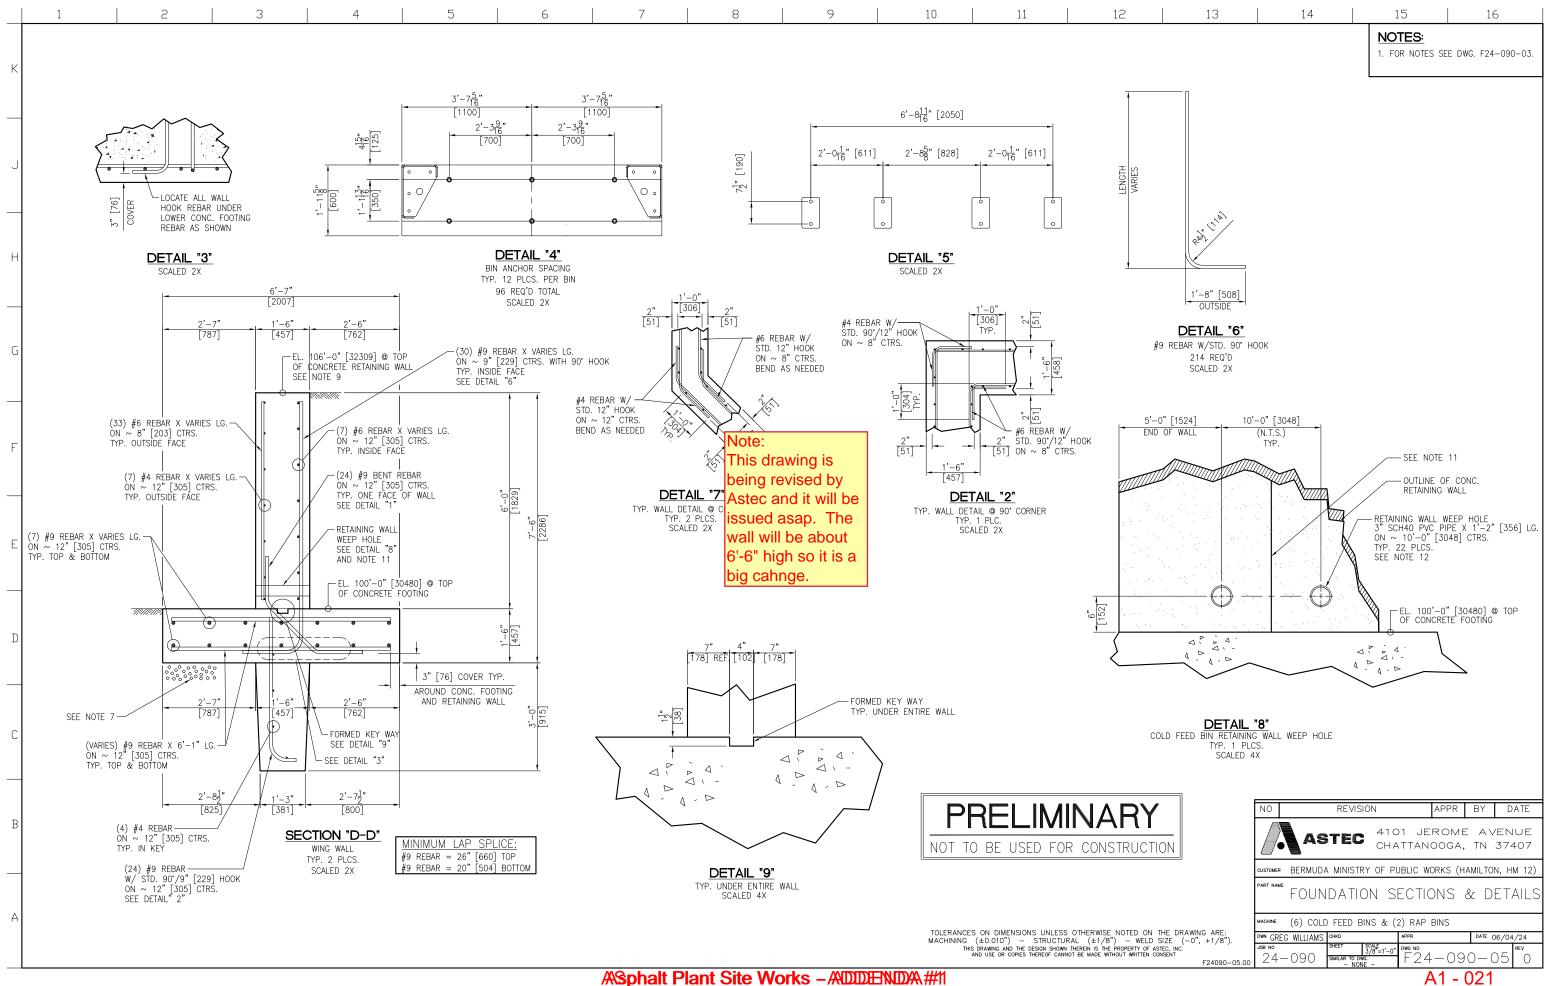


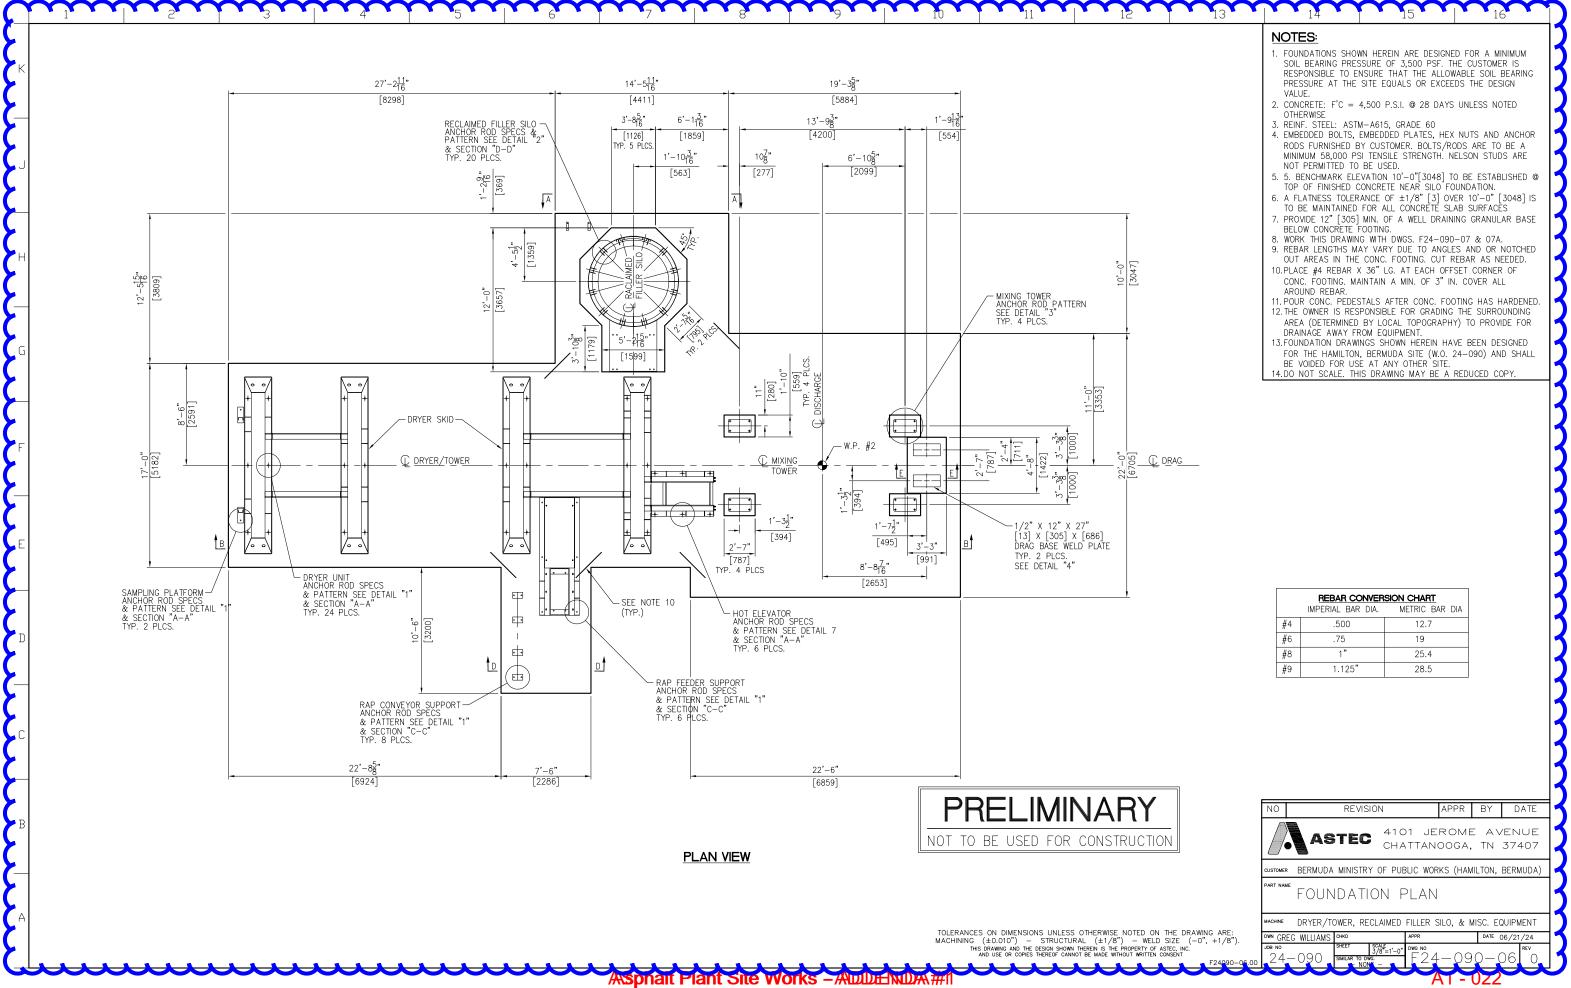


	REBAR CONVERSION CHART								
	IMPERIAL BAR DIA.	METRIC BAR DIA							
#4	.500	12.7							
#6	.75	19							
#8	1"	25.4							
#9	1.125"	28.5							

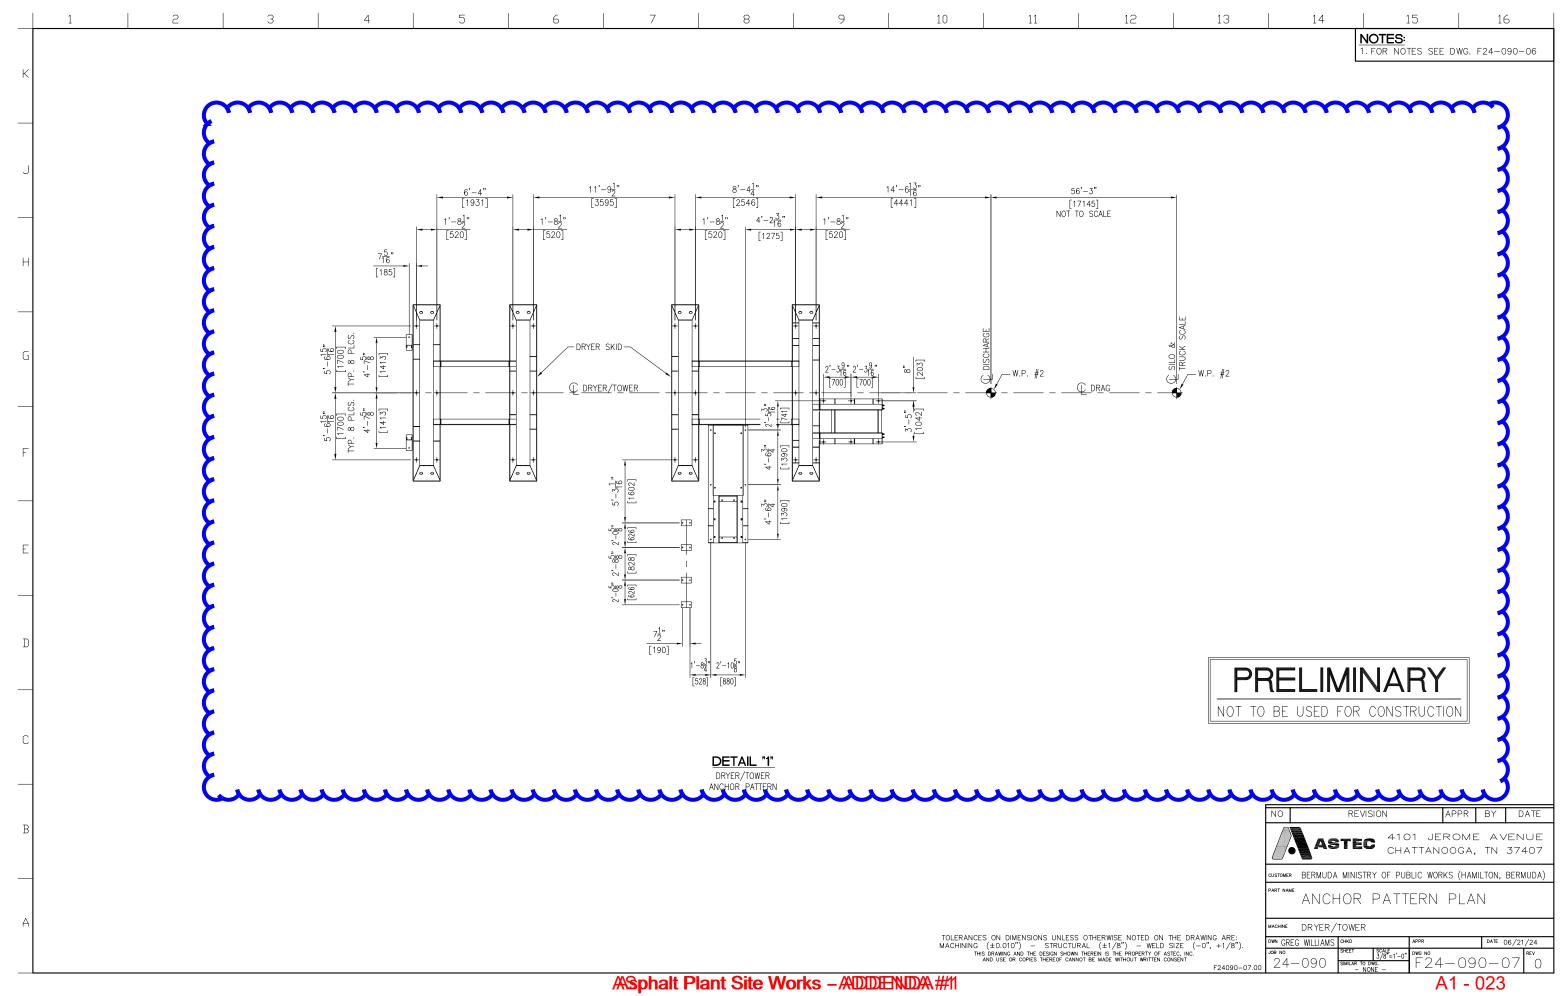


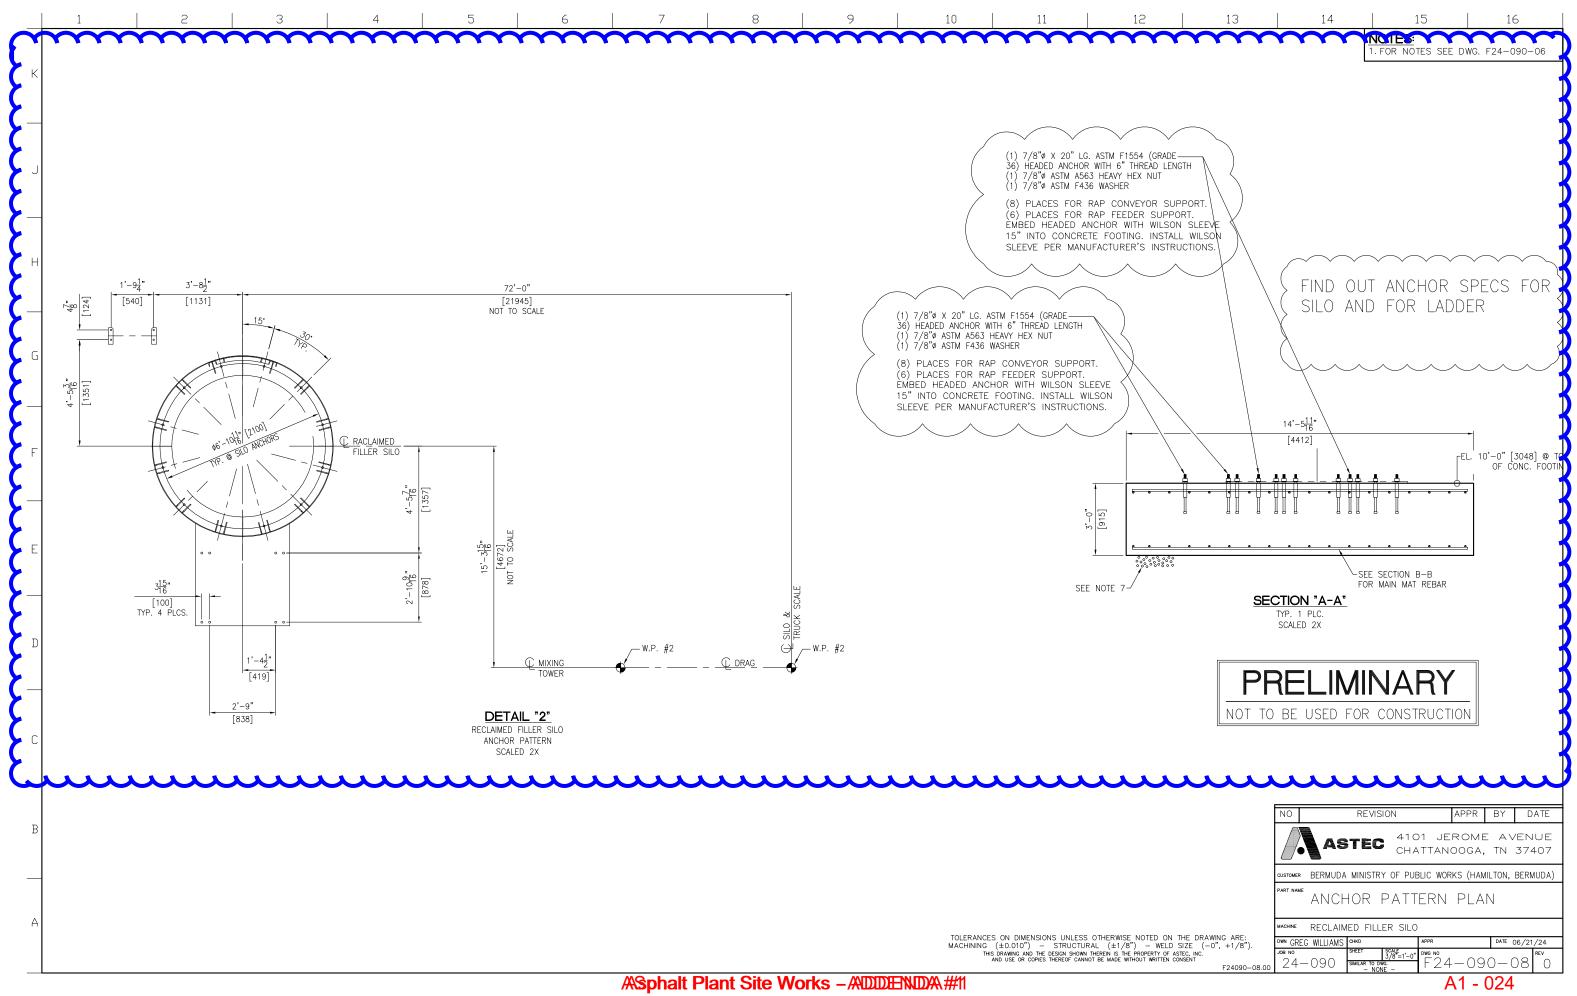

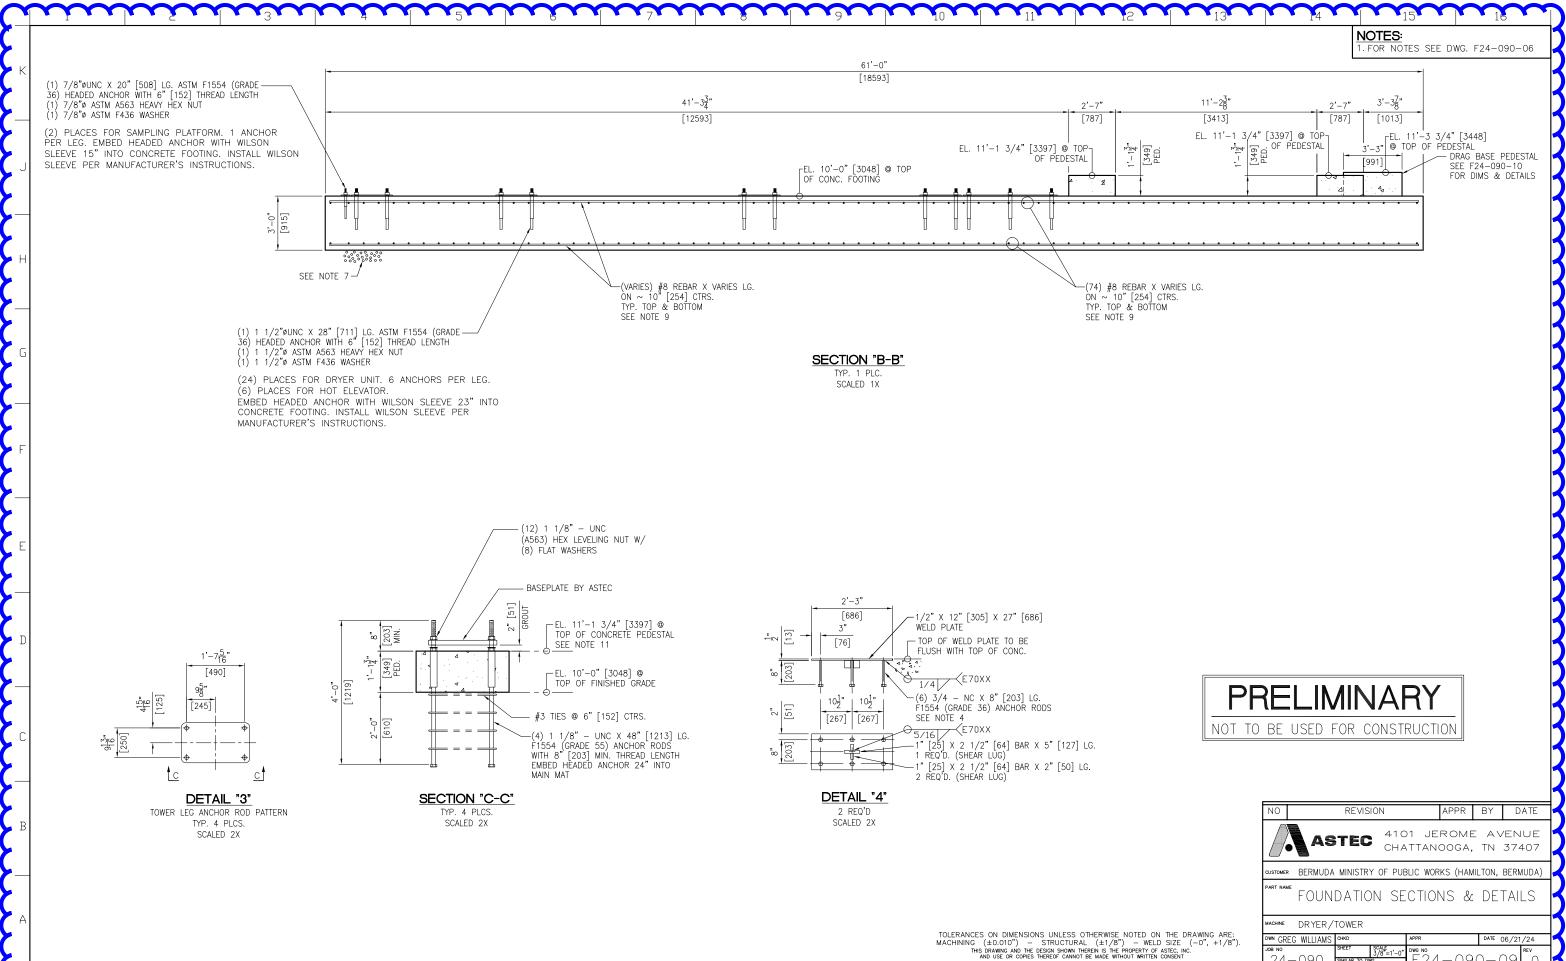

NO		REVISION	J		APPR	ΒY	DA	TE
	As	TEC						
CUSTOMER	BERMUDA	MINISTRY C	F PUE	BLIC WOR	KS (HAM	ILTON,	BERMU	JDA)
PART NAME	FOUN	DATION	SE	CTIO	VS &	DE	TAIL	S
MACHINE	DRYER/	TOWER						
DWN GRE	G WILLIAMS			APPR		DATE (06/21/2	24
јов NO 24-	-090	3/8 SIMILAR TO DWG.		f24	-09	0-0)9 ^{re}	ev ()
			ト			2		人
	CUSTOMER PART NAME MACHINE DWN GRE JOB NO	CUSTOMER BERMUDA PART NAME FOUN MACHINE DRYER/ DWN GREG WILLIAMS	ASTEC OUSTOMER BERMUDA MINISTRY C PART NAME FOUNDATION MACHINE DRYER/TOWER DWN CREC WILLIAMS OHRO SHEET ISA 24-090 SHEET ISA SHALAR TO DWC	ASTEC 41 C CHA OUSTOMER BERMUDA MINISTRY OF PUE PART NAME FOUNDATION SE MACHINE DRYER/TOWER DIVN GREG WILLIAMS OHKO JOB NO SHEET 3/8"=1"-0"	ASTEC 4101 JE CHATTANG CUSTOMER BERMUDA MINISTRY OF PUBLIC WOR PART NAME FOUNDATION SECTION MACHINE DRYER/TOWER DWN CREC WILLIAMS OHKO SHEET SCAFE 24-090 SHEET SCAFE 24-090 DHIG NO 24-090	ASTEC 4101 JEROME CHATTANOOGA, OUSTOMER BERMUDA MINISTRY OF PUBLIC WORKS (HAM PART NAME FOUNDATION SECTIONS & MACHINE DRYER/TOWER DWN CREG WILLIAMS OHKO SHEET SCALE JOB NO 24-090 SHEET SCALE 24-090	ASTEC 4101 JEROME AV CHATTANOOGA, TN OUSTOMER BERMUDA MINISTRY OF PUBLIC WORKS (HAMILTON, PART NAME FOUNDATION SECTIONS & DET MACHINE DRYER/TOWER DWN CREG WILLIAMS OHEO JOB NO 24-090 SMELAR TO DWC NO 24-090 SMELAR TO DWC NO 24-090 - (ASTEC 4101 JEROME AVENU CHATTANOOGA, TN 3744 OUSTOMER BERMUDA MINISTRY OF PUBLIC WORKS (HAMILTON, BERMU PART NAME FOUNDATION SECTIONS & DETAIL MACHINE DRYER/TOWER DWN CREC WILLIAMS CHO DWN CREC WILLIAMS CHO SHEET 3/8 ⁸ -1-0 ¹ 24-090 SHEET 3/8 ⁸ -1-0 ² SHARE TO DWC. NO 24-090 SHEET 3/8 ⁸ -1-0 ² SHARE TO DWC. NO SHARE TO SHARE TO S

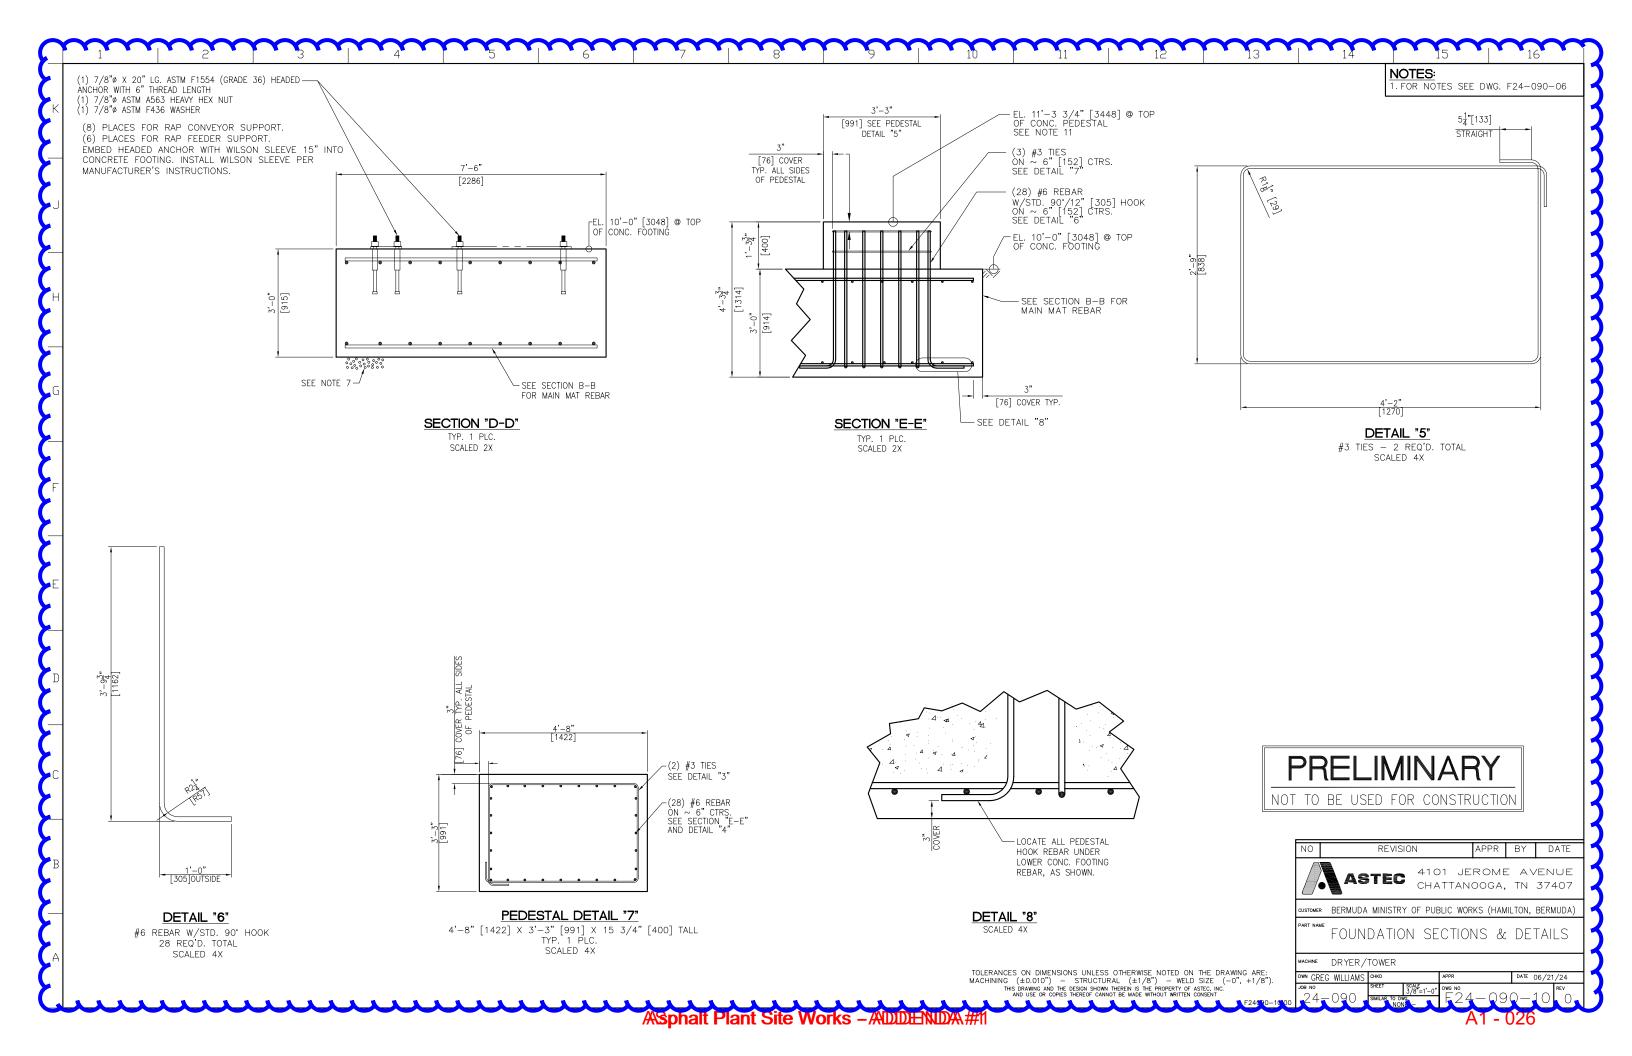

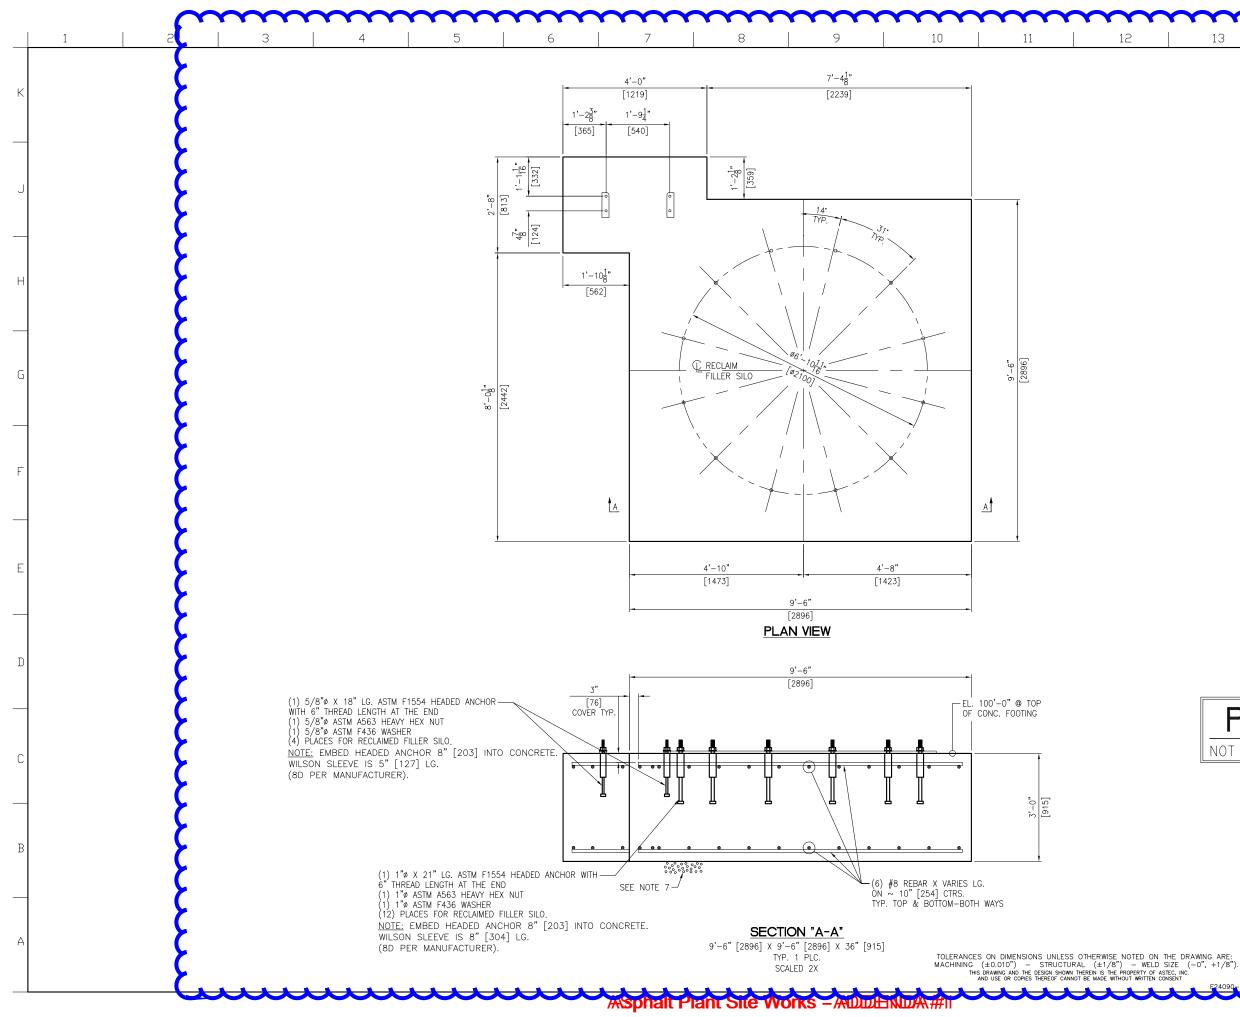


13	14	15	16
	NOTES:		
	SOIL BEARING PRES RESPONSIBLE TO EN PRESSURE AT THE VALUE.	WN HEREIN ARE DESIGNE SSURE OF 2,000 PSF. TI NSURE THAT THE ALLOV SITE EQUALS OR EXCEE	HE CUSTOMER IS /ABLE SOIL BEARING DS THE DESIGN
	2. CONCRETE: F'C = · OTHERWISE	4,000 P.S.I. @ 28 DAYS	UNLESS NOTED
	3. REINF. STEEL: ASTM		
	RODS FURNISHED B	EMBEDDED PLATES, HEX Y CUSTOMER. BOLTS/RO TENSILE STRENGTH. N DE USED	DDS ARE TO BE A
	5. 5. BENCHMARK ELE	VATION 100'-0"[30480] CONCRETE NEAR DRAG	
	6. A FLATNESS TOLER TO BE MAINTAINED	ANCE OF ±1/8" [3] OV FOR ALL CONCRETE SL	ER 10'—0" [3048] IS AB SURFACES
	7. PROVIDE 12" [305] BELOW CONCRETE F	MIN. OF A WELL DRAIN	ING GRANULAR BASE
	8. REBAR LENGTHS M/	AY VARY DUE TO ANGLE CONC. FOOTING. CUT F	
	9. THE OWNER IS RES AREA (DETERMINED	PONSIBLE FOR GRADING BY LOCAL TOPOGRAPH	THE SURROUNDING
	DRAINAGE AWAY FR 10. FOUNDATION DRAW	ROM EQUIPMENT. NGS SHOWN HEREIN HA	VE BEEN DESIGNED
	FOR THE HAMILTON	, BERMUDA SITE (W.O. :	
		E AT ANY OTHER SITE. IS DRAWING MAY BE A	REDUCED COPY

REBAR CONVERSION CHART		
	IMPERIAL BAR DIA.	METRIC BAR DIA
#4	.500	12.7
#6	.75	19
#8	1"	25.4
#9	1.125"	28.5

PRELIMINARY NOT TO BE USED FOR CONSTRUCTION

REVISION APPR BY DATE 4101 JEROME AVENUE ASTEC CHATTANOOGA, TN 37407 /•` USTOMER BERMUDA MINISTRY OF PUBLIC WORKS (HAMILTON, HM 12) ART NAME FOUNDATION PLAN & SECTIONS ACHINE RECLAIMED FILLER SILO DWN GREG WILLIAMS CHKD DATE 06/21/24 SCALE 3/8"=1'-0" DWG NO 090. nar 027

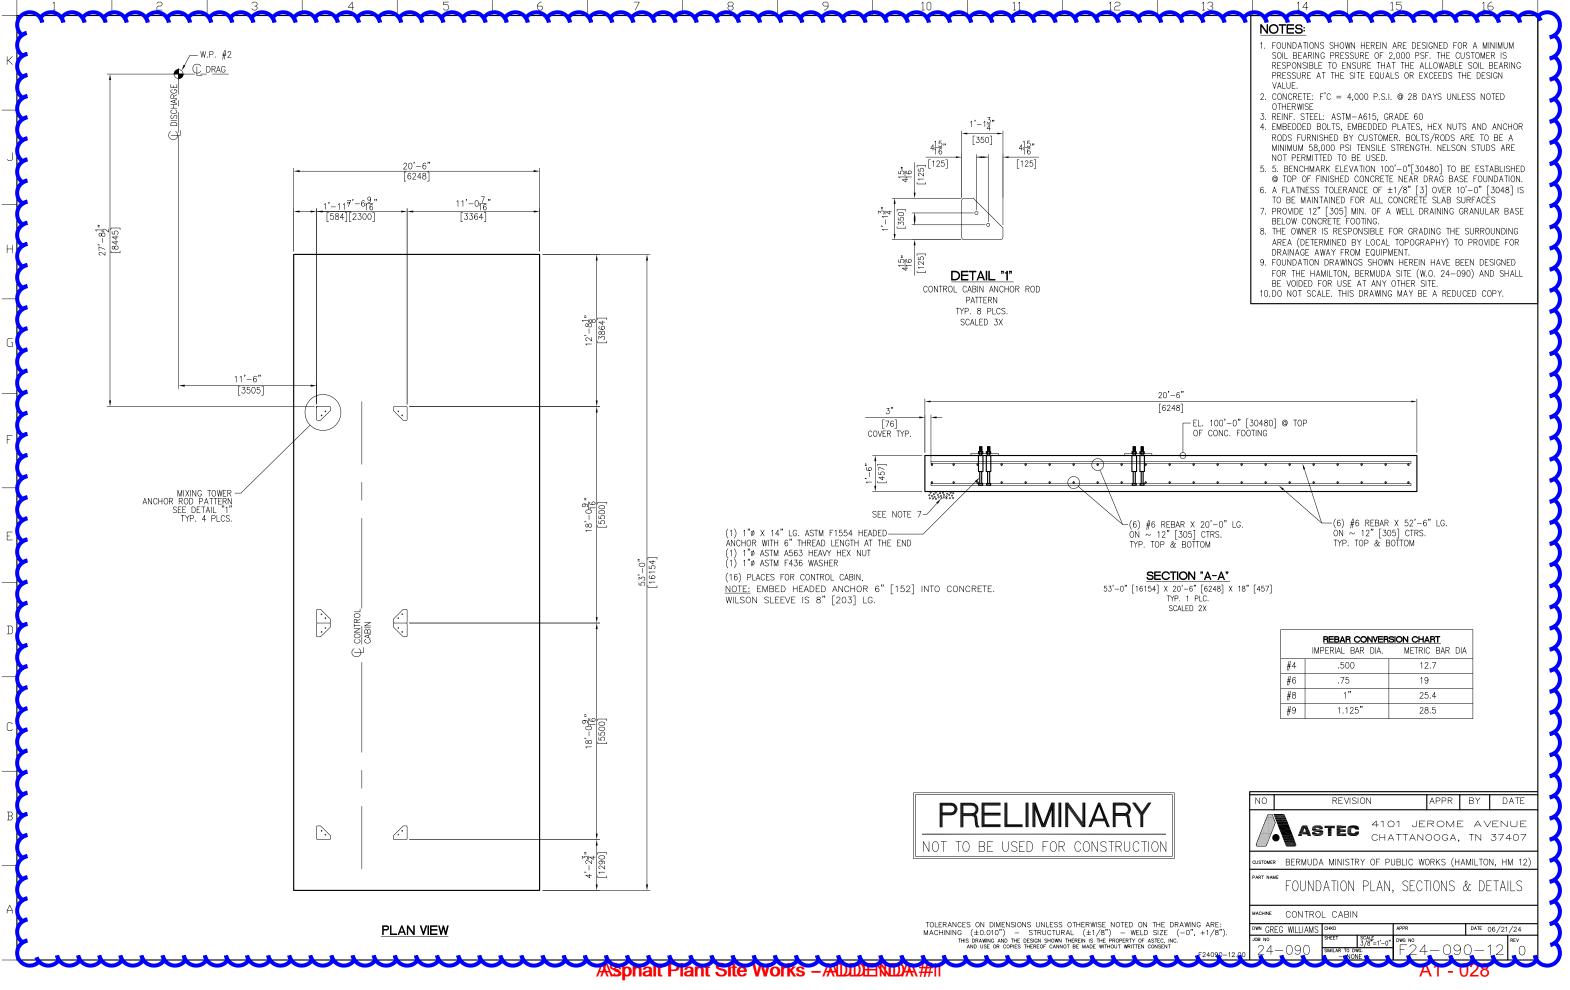

REBAR CONVERSION CHART		
	IMPERIAL BAR DIA.	METRIC BAR DIA
#4	.500	12.7
#6	.75	19
#8	1"	25.4
# 9	1.125"	28.5